EXHIBIT E

96 in.

PROVIDED BY PROJECT MANAGER .....Project Name..... **PUBLIC WORKS DEPARTMENT** SIGNED CAPITAL PROJECTS ASSIGNED CAPITAL PROJECTS CITY OF SAN ANTONIO I.5" CALIBRI BLACK\_FONT, 0.58" LINE SPACE -2.5" CALIBRI B\_ACK BOLDFACE FONT, 0.80" LINE SPACE -3" CALIBRI BLACK BOLDFACE FONT, 0.80" LINE SPACE MYRIAD PRO BOLDFACE CONDENSED FONT FOR MORE INFORMATION CALL: 310-20**CITY OF SAN ANTONIO** ......Design Engineers/Architects..... .....Project Name..... AFTER HOURS EMERGENCIES CALL 311 AND REFER TO: PARA EMERGENCÍAS, DESPUÉS DE HORA, LLAME 311 Y MENCIONE: J BACK SAN ANTONIO

PROVIDE ADEQUATE SUPPORTS FOR SIGN AS SITE CONDITIONS MAY REQUIRE AND KEEP SIGN PROPER DISTANCE ABOVE PREVAILING GRADE TO PERMIT PUBLIC VIEWING

EXTERIOR TYPE HIGH DENSITY OVERLAID 0.5" PLYWOOD OR OTHER APPROVED MATERIAL

SUITABLE FOR SIGNS.

GRADE

FONT (SAME LETTER HEIGHT & WIDTH): CALIBRI

LEFT BORDER SHALL BE
DETERMINED USING THE
LONGEST LINE CENTERED
ON THE SIGN PROVIDING
EQUAL BORDERS

ABCDEFGHIJKLMNOPQRSTUVWXYZ abcdefghijklmnopqrstuvwxyz 0123456789!\$&-()<>:;,./?

### **CONSTRUCTION DOCUMENT ORGANIZATION**

This set of CONSTRUCTION DOCUMENTS is presented in two parts - a set of technical SPECIFICATIONS and a set of DRAWINGS on 24" x 36" sheets.

Specifications are organized according to the 16 divisions of the UNIFORM CONSTRUCTION INDEX as follows:

Division 1 General Requirements Division 2 Existing Conditions Division 3 Concrete Division 4 Masonry

Division 5 Metals Division 6 Wood, Plastics, and Composites Division 7 Thermal and Moisture Protection Division 8 Openings (This section contains door schedule and hardware schedule) 9 Finishes (This section contains room

finish schedule) 10 Specialities Division Division 11 Equipment Division 12 Furnishings

Division 13 Special Construction Division 14 Conveying Equipment Division 21 Fire Suppression Division 22 Plumbing 23 Heating Ventilating and Air Conditioning Division

Division 26 Electrical Division 27 Communications Division 28 Electronic Safety and Security Division 31 Earthwork 32 Exterior Improvements

### DRAWINGS

Division 33 Utilities

DRAWINGS are organized according to disciplines, with each discipline describing a general aspect of the construction. Disciplines are arranged as follows:

A - ARCHITECTURAL Work required to produce the basic building envelope, including: floor plan(s), roof plan(s), exterior elevation, building sections, wall sections, stair details, exterior enclosure details.

M - MECHANICAL Work related to heating, ventilating, cooling and plumbing

E - ELECTRICAL Work related to electrical systems. P - PLUMBING

Work related to plumbing systems.

## 3. SHEET NUMBERING

Each sheet of drawing is numbered in the lower right hand corner. Sheets are numbered sequentially.


## DRAWING NUMBERING

Detailed Floor Plan

Each drawing is numbered preceding the drawing title. Drawings are numbered first by the sheet number, then by the drawing number.

### 5. SYMBOLS



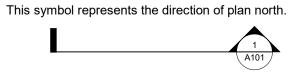

This symbol is a key to a building section drawing taken along the straight line of the symbol. The arrow points in the direction of the view for the section. The number is a reference to the section drawing.

This symbol is a key to a wall section drawing taken along the straight line of the symbol. The arrow points in the direction of the view for the section. The number is a reference to the section drawing.

## **CODE ANALYSIS:**

NCB 13814 BLK 3 LOT PT OF 12 ARB 12G DESCRIPTION (GIS AS 3.847 AC) ABSTRACT NBHD CODE 10031 PROPERTY IDENTIFICATION NUMBER 535967

I. <u>ZONING</u> ZONING CLASSIFICATION DOWNTOWN ZONING DISTRICT HISTORIC DISTRICT

HISTORIC EXCEPTIONAL HISTORIC SIGNIFICANT RIVER DISTRICT 3

This symbol is a key to the door schedule. All doors are keyed with a letter prefix followed by door number.

This symbol is a key to an elevation drawing. The arrow points in

the direction of the view for the elevation. The number is a

This symbol is a key to a detail drawn of the area within the

circle. The number is a reference to the detail drawing.

reference to the elevation drawing.

A system of KEY NOTES containing written description and notation is used for all architectural plan and elevation drawings. KEY NOTES are typically located in a column along the right side

## DRAWING NOTES


PLASTIC LAMINATE (EXAMPLE)—

of each sheet. Each note is numbered and keyed to a

corresponding circled number on the appropriate drawing.

A system of DRAWING NOTES containing written description and notation is used for all section and details drawings. DRAWING NOTES are located adjacent to each drawing on the sheet.

## PARTITION TYPE

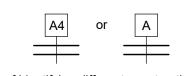

A system of identifying different construction types of partitions. Single hexagon containing a number or combination of number and letter which is indicated on floor plans and the corresponding partition type is described as section detail in the partition type sheet.

## **DIMENSIONS**

All plan dimensions are to the face of wall finish or face of masonry unless otherwise noted. All vertical dimensions are nominal and assume a level finish floor condition. Run all horizontal reveals level. Field verify exact vertical dimension.

### LEGAL DESCRIPTION

600 E. HEMISFAIR PLAZA WAY BUILDING 277

AIRPORT HAZARD OVERLAY DISTRICT 2018 INTERNATIONAL BUILDING CODE (IBC) II. <u>BUILDING CODE</u>

2018 INTERNATIONAL ENERGY CONSERVATION CODE 2018 INTERNATIONAL MECHANICAL CODE 2018 INTERNATIONAL PLUMBING CODE 2017 NATIONAL ELECTRIC CODE 2012 TEXAS ACCESSIBILITY STANDARDS

OWNER CITY OF SAN ANTONIO / HEMISFAIR PARK - REDEVELOPMENT

CONSTRUCTION TYPE TYPE II B SQUARE FOOTAGE FIRST FLOOR TOTAL AREA 16,040 GSF

SECOND FLOOR TOTAL AREA 12,444 GSF TOTAL GROSS AREA 28,484 GSF ALLOWABLE SQUARE FOOTAGE 141,220 GSF BUILDING HEIGHT 28' - 8" ALLOWABLE 55' - 0"

2 STORIES BUILDING NUMBER OF STORIES ALLOWABLE 3 STORIES OCCUPANCY TYPE BUSINESS

## OCCUPANCY LOAD PRIMARY USE

FIRST FLOOR 4,415 SQFT / 150 = 29 OCCUPANTS SECOND FLOOR 9,064 SQFT / 150 = 60 OCCUPANTS

2018 EXISTING INTERNATIONAL BUILDING CODE

2018 INTERNATIONAL FIRE CODE

STORAGE 1 PER 300 FIRST FLOOR 1,691 SQFT / 30 = 6 OCCUPANTS SECOND FLOOR 110 SQFT / 30 = 1 OCCUPANTS

 
 FIXED SEATS
 1 PER 15

 FIRST FLOOR
 5,424 SQFT / 15 = 361 OCCUPANTS
 SECOND FLOOR 845 SQFT / 15 = 56 OCCUPANTS

FIRST FLOOR 286 SQFT / 50 = 5 OCCUPANTS

LOCKER ROOM 1 PER 50 FIRST FLOOR 2,005 SQFT 2,005 SQFT / 50 = 40 OCCUPANTS

MECHANICAL ROOM 1 PER 300 FIRST FLOOR 580 SQFT / 300 = 2 OCCUPANTS SECOND FLOOR 767 SQFT / 300 = 3 OCCUPANTS

433 OCCUPANTS SECOND FLOOR 120 OCCUPANTS

TOTAL BUILDING OCCUPANTS 553 OCCUPANTS **EXITS REQUIRED** FIRST FLOOR 433 OCCUPANTS X .2 = 86 INCHES REQUIRED, 264 INCHES PROVIDED SECOND FLOOR 120 OCCUPANTS X .3 = 36 INCHES REQUIRED, 100 INCHES PROVIDED

EXISTING - PROVIDED BY HEMISFAIR PARK REDEVELOPMENT CORPORATION (HPARC) OFFICE - MINIMUM REQUIRED - 95 SPACES - MAXIMUM SPACES REQUIRED 204

EXISTING PARKING SPACES PROVIDED - 95 PARKING LOT **46 PARKING OVERFLOW** 2 ONSITE PARKING SPACES

NEW SPACES PROVIDED 1 VAN - ACCESSIBLE SPACE ON SITE 4 ACCESSIBLE SPACES NEAR SITE

> 5 ACCESSIBLE SPACES REQUIRED INCLUDING ONE VAN ACCESSIBLE SPACE 5 ACCESSIBLE SPACES PROVIDED INCLUDING ONE VAN ACCESSIBLE SPACE

# **SCOPE OF WORK SUMMARY:**

THE WORK OF THE PROJECT IS DEFINED BY THE CONTRACT DOCUMENTS AND CONSISTS, BUT NOT LIMITED, OF THE FOLLOWING:


- 1. FIRST FLOOR WORK CONSIST OF NEW LOCKER/SHOWER ROOMS FOR MEN AND WOMAN, AND INTERIOR RENOVATIONS.
- SECOND FLOOR WORK CONSIST OF NEW ADA TOILET ROOMS/SHOWER ROOM AND INTERIOR RENOVATIONS.
- 3. NEW MECHANICAL UNITS WITH NEW DUCTWORK 4. NEW ELECTRICAL EMERGENCY GENERATOR.
- 5. NEW FIRE SPRINKLER SYSTEM. 6. NEW PLUMBING. 7. NEW DATA / SECUITY.

SHEET NUMBER	SHEET NAME
	OTTEET TO WILL
GENERAL	OOVED OUEET
A000	COVER SHEET
A0.1	INDEX, SYMBOLS, ABBREVIATIONS, CODE ANALYSIS
A0.2	DEMOLITION AND NEW CONSTRUCTION GENERAL NOTES
A0.3	LIFE SAFETY PLAN
A0.4	ACCESSIBILITY STANDARDS
A0.5	ALTERNATES
CIVIL	
C1.0	SITE PLAN
C2.0	SITE PLAN DETAILS
LANDSCAF	
L100	TREE PRESERVATION PLAN
L101	TREE PRESERVATION DETAILS
L200	LANDSCAPE PLAN
ARCHITEC	TURAL
A1.1	DEMOLITION SITE PLAN
A1.2	DEMOLITION FIRST FLOOR PLAN
A1.3	DEMOLITION SECOND FLOOR PLAN
A1.4	DEMOLITION ROOF PLAN
A1.5	DEMOLITION PHOTOS
A1.6	DEMOLITION PHOTOS
A2.1	NEW SITE PLAN
A2.2	NEW CONSTRUCTION FIRST FLOOR PLAN
A2.3	NEW CONSTRUCTION SECOND FLOOR PLAN
A2.4	NEW ROOF PLAN
A2.4b	ROOF DETAILS
A2.5	FIRST FLOOR NEW WORK DIMENSION PLAN
A2.6	PARTITION TYPES
A2.7	PARTITION TYPES
A2.8	DOOR & FRAME LEGEND, SCHEDULE & DETAILS
A2.9	WINDOW SCHEDULE & DETAILS
A2.10	WINDOW SCHEDULE & DETAILS
A3.1	EXTERIOR ELEVATIONS
A3.2	WALL SECTIONS
A3.2 A3.3	BUILDING SECTIONS
A4.1	ENLARGED RESTROOMS PLAN
A4.2	ENLARGED LOCKER ROOMS PLAN
A4.3	EPOXY FLOOR ISOMETRIC VIEWS
A4.4	ENLARGED STAIR PLAN
A5.1	INTERIOR ELEVATIONS
A5.2	MILLWORK SECTIONS
A6.1	DEMOLITION FIRST FLOOR RCP
A6.2	DEMOLITION SECOND FLOOR RCP
A6.3	NEW FIRST FLOOR RCP
A6.4	NEW SECOND FLOOR RCP
A8.1	PLAN DETAILS
A10.1	EQUIPMENT PLANS
A11.1	ROOM FINISH SCHEDULE AND FINISH LEGEND
A11.2	FIRST FLOOR NEW CONSTRUCTION FLOOR PATTERN PLAN
A11.3	SECOND FLOOR NEW CONSTRUCTION FLOOR PATTERN PLAN
	NEW CONSTRUCTION ENLARGED FINISH FLOOR PLANS
A11.4	
STRUCTUE	
S0.1	STRUCTURAL NOTES
S0.2	SPECIAL INSPECTIONS
S1.1	EXISTING FOUNDATION PLAN
S1.2	EXISTING SECOND FLOOR FRAMING PLAN
S1.3	EXISTING ROOF FRAMING PLAN
	FRAMING DETAILS
S2.1	
S2.2	TYPICAL CONCRETE FRAMING DETAILS

SHEET INDEX

	SHEET INDEX		SHELTINDEX
HEET MBER	SHEET NAME	SHEET NUMBER	SHEET NAME
		N45011ANU	
IERAL	OOVED OUEET	MECHANIC	
J	COVER SHEET	M000	MECHANICAL SYMBOLS & ABBREVIATIONS
<u> </u>	INDEX, SYMBOLS, ABBREVIATIONS, CODE ANALYSIS	MD101 MD102	MECHANICAL FIRST FLOOR - DEMOLITION  MECHANICAL SECOND FLOOR - DEMOLITION
	DEMOLITION AND NEW CONSTRUCTION GENERAL NOTES LIFE SAFETY PLAN	MD102	MECHANICAL SECOND FLOOR - DEMOLITION  MECHANICAL ROOF PLAN - DEMOLITION
)	ACCESSIBILITY STANDARDS	M101	MECHANICAL ROOF PLAN  MECHANICAL FLOOR PLAN
•	ALTERNATES	M102	MECHANICAL FLOOR PLAN
<u>'</u> I	ALILINATES	M103	MECHANICAL ROOF PLAN
<u> </u>	SITE PLAN	M201	ENLARGED MECHANICAL PLAN
<u>'                                    </u>	SITE PLAN DETAILS	M300	MECHANICAL SCHEDULES
DSCAF		M301	MECHANICAL SCHEDULES
)	TREE PRESERVATION PLAN	M400	MECHANICAL CONTROLS
1	TREE PRESERVATION DETAILS	M401	MECHANICAL CONTROLS
)	LANDSCAPE PLAN	M402	MECHANICAL CONTROLS
HITEC	TURAL	M500	MECHANICAL DETAILS
	DEMOLITION SITE PLAN	M501	MECHANICAL DETAILS
) •	DEMOLITION FIRST FLOOR PLAN	M502	MECHANICAL DETAILS
}	DEMOLITION SECOND FLOOR PLAN	M503	MECHANICAL DETAILS
	DEMOLITION ROOF PLAN	ELECTRIC	AL
· )	DEMOLITION PHOTOS	E000	ELECTRICAL SYMBOLS & ABBREVIATIONS
<b>)</b>	DEMOLITION PHOTOS	E001	SITE PLAN
	NEW SITE PLAN	E002	ELECTRICAL GENERAL NOTES
	NEW CONSTRUCTION FIRST FLOOR PLAN	ED101	FIRST FLOOR ELECTRICAL DEMOLITION FLOOR PLAN
<b> </b>	NEW CONSTRUCTION SECOND FLOOR PLAN	ED102	SECOND FLOOR ELECTRICAL DEMOLITION PLAN
•	NEW ROOF PLAN	ED103	ROOF ELECTRICAL DEMOLITION PLAN
-b	ROOF DETAILS	E101	FIRST FLOOR ELECTRICAL LIGHTING FLOOR PLAN
	FIRST FLOOR NEW WORK DIMENSION PLAN	E102	SECOND FLOOR ELECTRICAL LIGHTING PLAN
<u>,                                      </u>	PARTITION TYPES	E103	LIGHTING FIXTURE DETAILS
	PARTITION TYPES	E201	FIRST FLOOR ELECTRICAL POWER FLOOR PLAN
<u> </u>	DOOR & FRAME LEGEND, SCHEDULE & DETAILS WINDOW SCHEDULE & DETAILS	E202	SECOND FLOOR ELECTRICAL POWER PLAN
0	WINDOW SCHEDULE & DETAILS WINDOW SCHEDULE & DETAILS	E301 E302	FIRST FLOOR ELECTRICAL SPECIAL SYSTEMS FLOOR PLAN SECOND FLOOR SPECIAL SYSTEMS FLOOR PLAN
U	EXTERIOR ELEVATIONS	E401	ELECTRICAL ONE-LINE DIAGRAM
)	WALL SECTIONS	E501	ELECTRICAL SCHEDULES
· }	BUILDING SECTIONS	E502	ELECTRICAL SCHEDULES
	ENLARGED RESTROOMS PLAN	E503	ELECTRICAL SCHEDULES
)	ENLARGED LOCKER ROOMS PLAN	E601	ELECTRICAL DETAILS
	EPOXY FLOOR ISOMETRIC VIEWS	EM201	FIRST FLOOR MECHANICAL POWER PLAN
	ENLARGED STAIR PLAN	EM202	SECOND FLOOR MECHANICAL POWER PLAN
	INTERIOR ELEVATIONS	EM203	ROOF MECHANICAL POWER PLAN
)	MILLWORK SECTIONS	PLUMBING	
	DEMOLITION FIRST FLOOR RCP	FP101	FIRE PROTECTION PLANS
•	DEMOLITION SECOND FLOOR RCP	P000	PLUMBING SYMBOLS & ABBREVIATIONS
}	NEW FIRST FLOOR RCP	PD101	PLUMBING FIRST FLOOR PLAN - DEMOLITION
•	NEW SECOND FLOOR RCP	PD102	PLUMBING SECOND FLOOR PLAN - DEMOLITION
	PLAN DETAILS	P100	PLUMBING UNDERFLOOR PLAN
.1	EQUIPMENT PLANS	P101	PLUMBING FIRST FLOOR PLAN
.1	ROOM FINISH SCHEDULE AND FINISH LEGEND	P102	PLUMBING SECOND FLOOR PLAN
.2	FIRST FLOOR NEW CONSTRUCTION FLOOR PATTERN PLAN	P103	PLUMBING ROOF PLAN
.3	SECOND FLOOR NEW CONSTRUCTION FLOOR PATTERN PLAN	P201	PLUMBING ENLARGED PLANS
.4 	NEW CONSTRUCTION ENLARGED FINISH FLOOR PLANS	P202	PLUMBING ENLARGED PLANS
UCTUF		P301	PLUMBING SCHEDULES
)	STRUCTURAL NOTES	P401	PLUMBING RISERS
	SPECIAL INSPECTIONS EXISTING FOUNDATION PLAN	P402 P501	PLUMBING RISERS PLUMBING DETAILS
)	EXISTING FOUNDATION PLAN  EXISTING SECOND FLOOR FRAMING PLAN	P501	PLUMBING DETAILS PLUMBING DETAILS
<u>.                                    </u>	EXISTING SECOND FLOOR FRANKING PLAN	TECHNOL	

SHEET INDEX

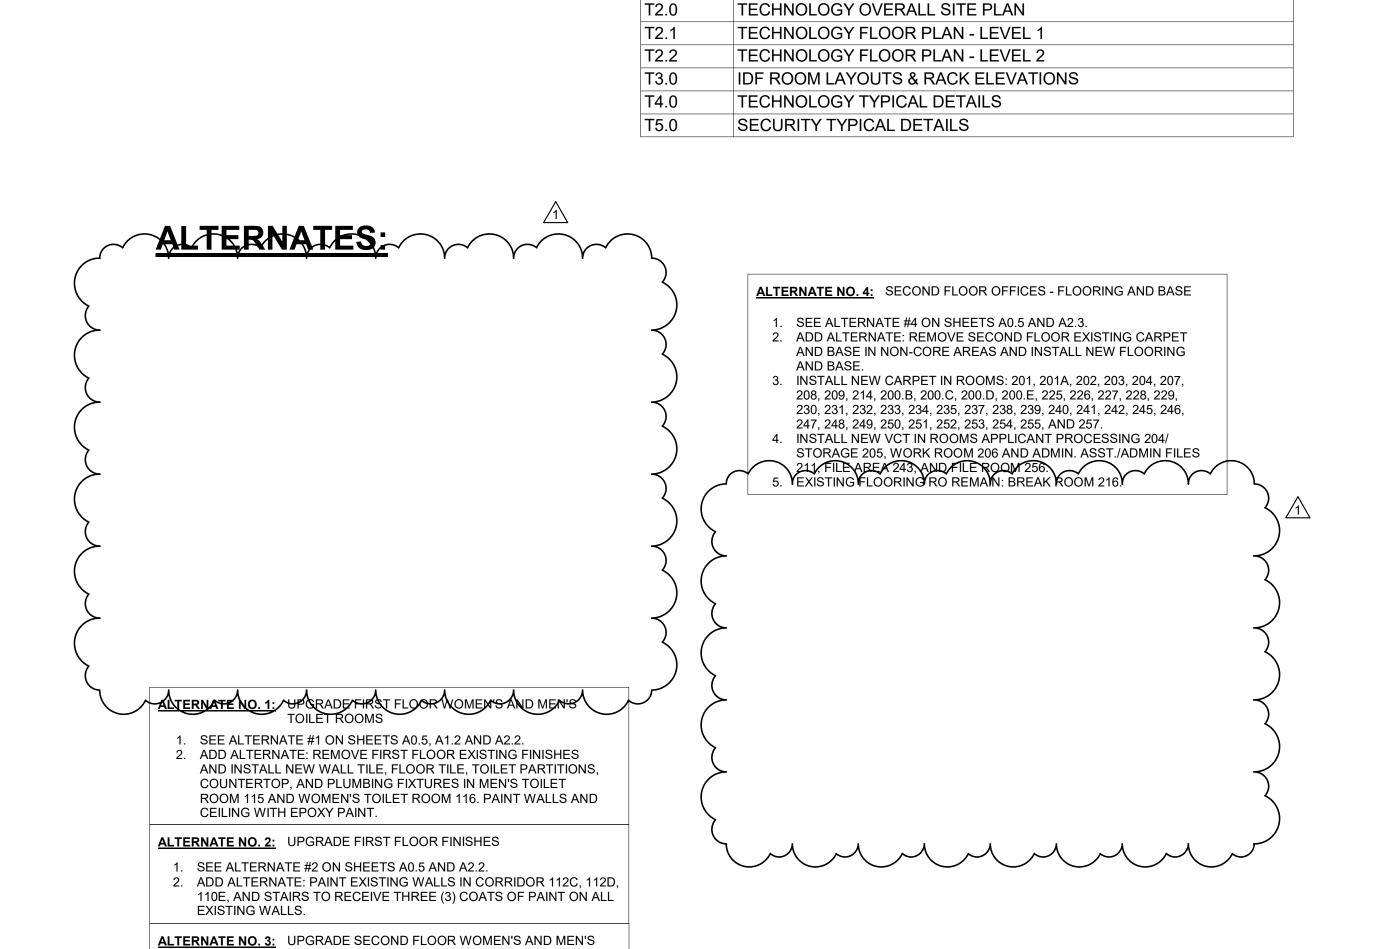

TOILET ROOMS; JANITOR'S CLOSET

2. ADD ALTERNATE: REMOVE SECOND FLOOR EXISTING FINISHES

AND INSTALL NEW WALL TILE, FLOOR TILE, TOILET PARTITIONS,

COUNTERTOP, AND PLUMBING FIXTURES IN MEN'S TOILET ROOM 220, JANITOR CLOSET 221, AND WOMEN'S ROOM 222. PAINT

WALLS AND CEILING WITH EPOXY PAINT IN MEN'S TOILET ROOM

220, JANITOR CLOSET 221 AND WOMEN'S TOILET ROOM 222.


1. SEE ALTERNATE #3 ON SHEETS A0.5, A1.3 AND A2.3.


**TECHNOLOGY** 

TECHNOLOGY SYMBOLS AND LEGEND

DEMOLITION FLOOR PLAN - LEVEL 1

DEMOLITION FLOOR PLAN - LEVEL 2

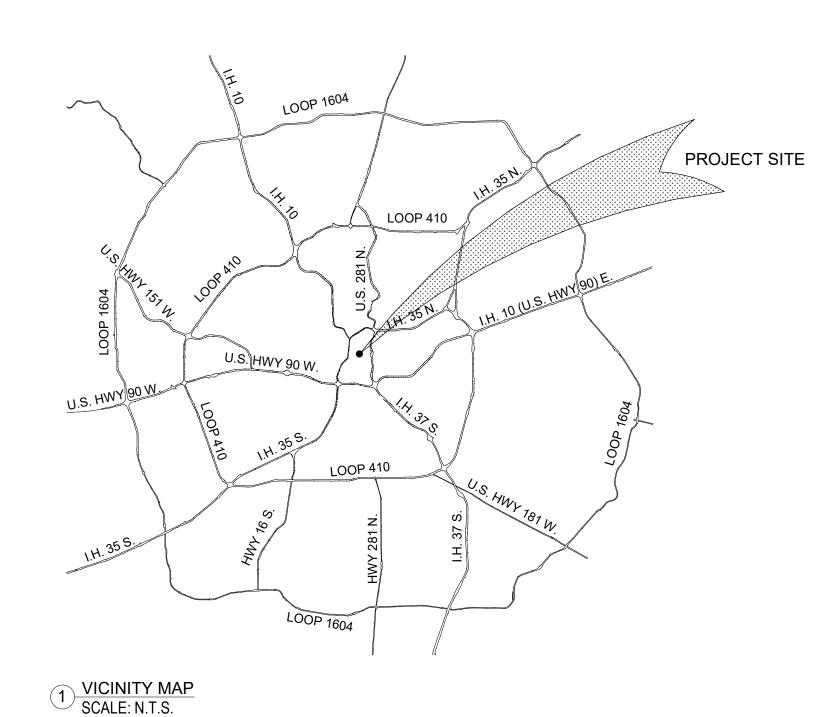

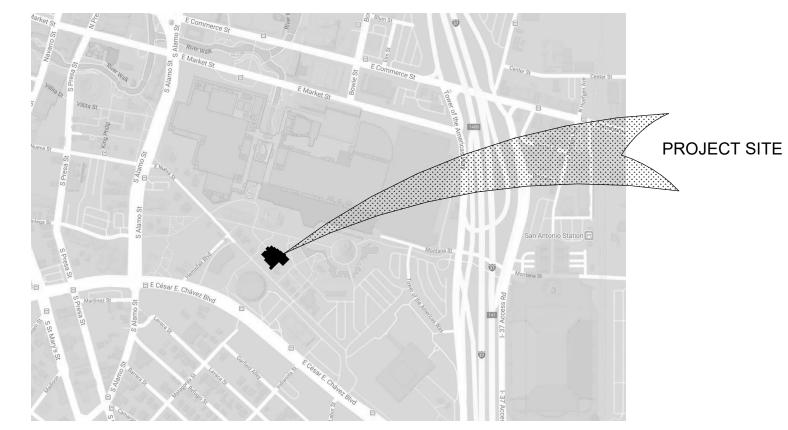


2 SITE LOCATION MAP SCALE: N.T.S.

# **EXHIBIT F**


INDEX, SYMBOLS, ABBREVIATIONS, CODE ENALYSIS PARTNERS, INC.

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Revision Schedule Description Date ADD #01 5/3/2021

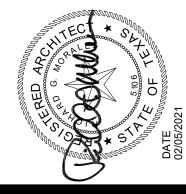
- SA 1 277 'S




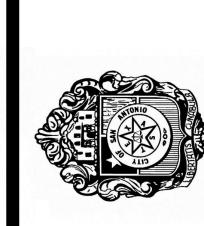

JOB NO: 1653.G 02/05/2021 DATE: DRAWN BY: CHECKED BY:

SHEET A0.1

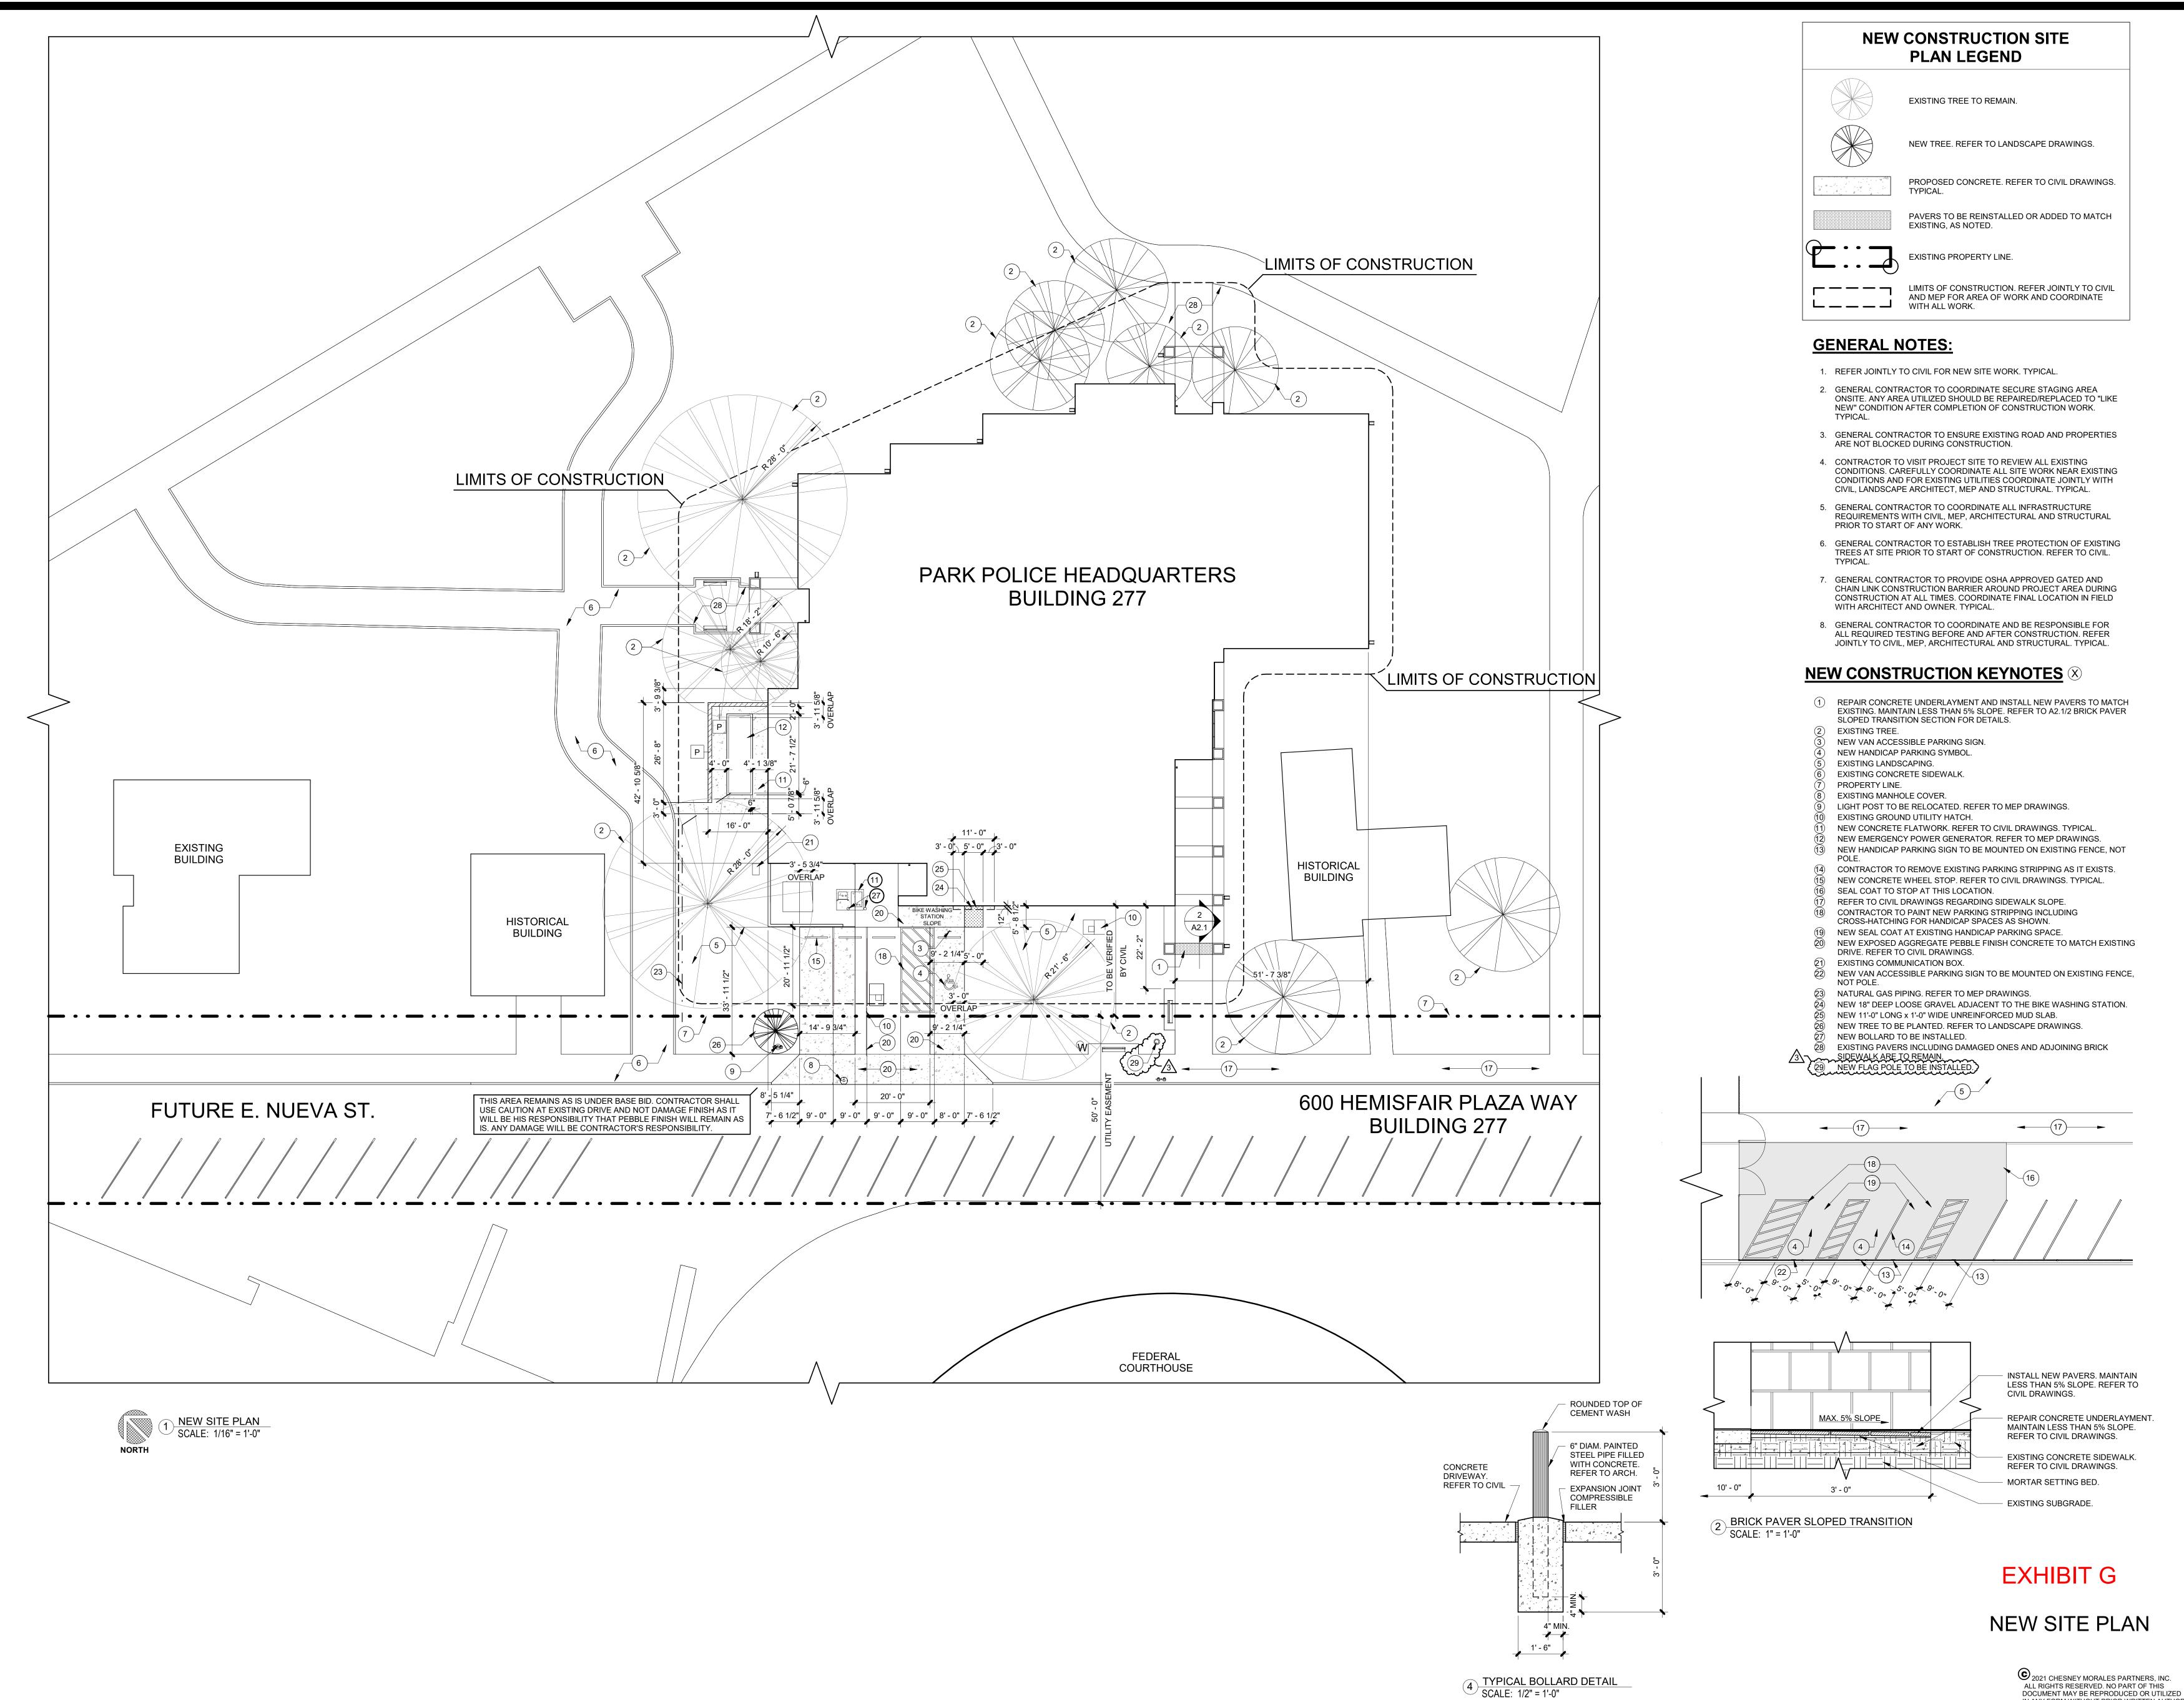


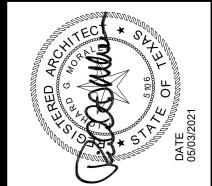

**Revision Schedule** Description Date ADD #03 4/30/21

IN ANY FORM WITHOUT PRIOR WRITTEN AUTHORIZATION OF CHESNEY MORALES PARTNERS, INC.

JOB NO: 1653.G 05/03/2021 DATE: DRAWN BY: CHECKED BY:

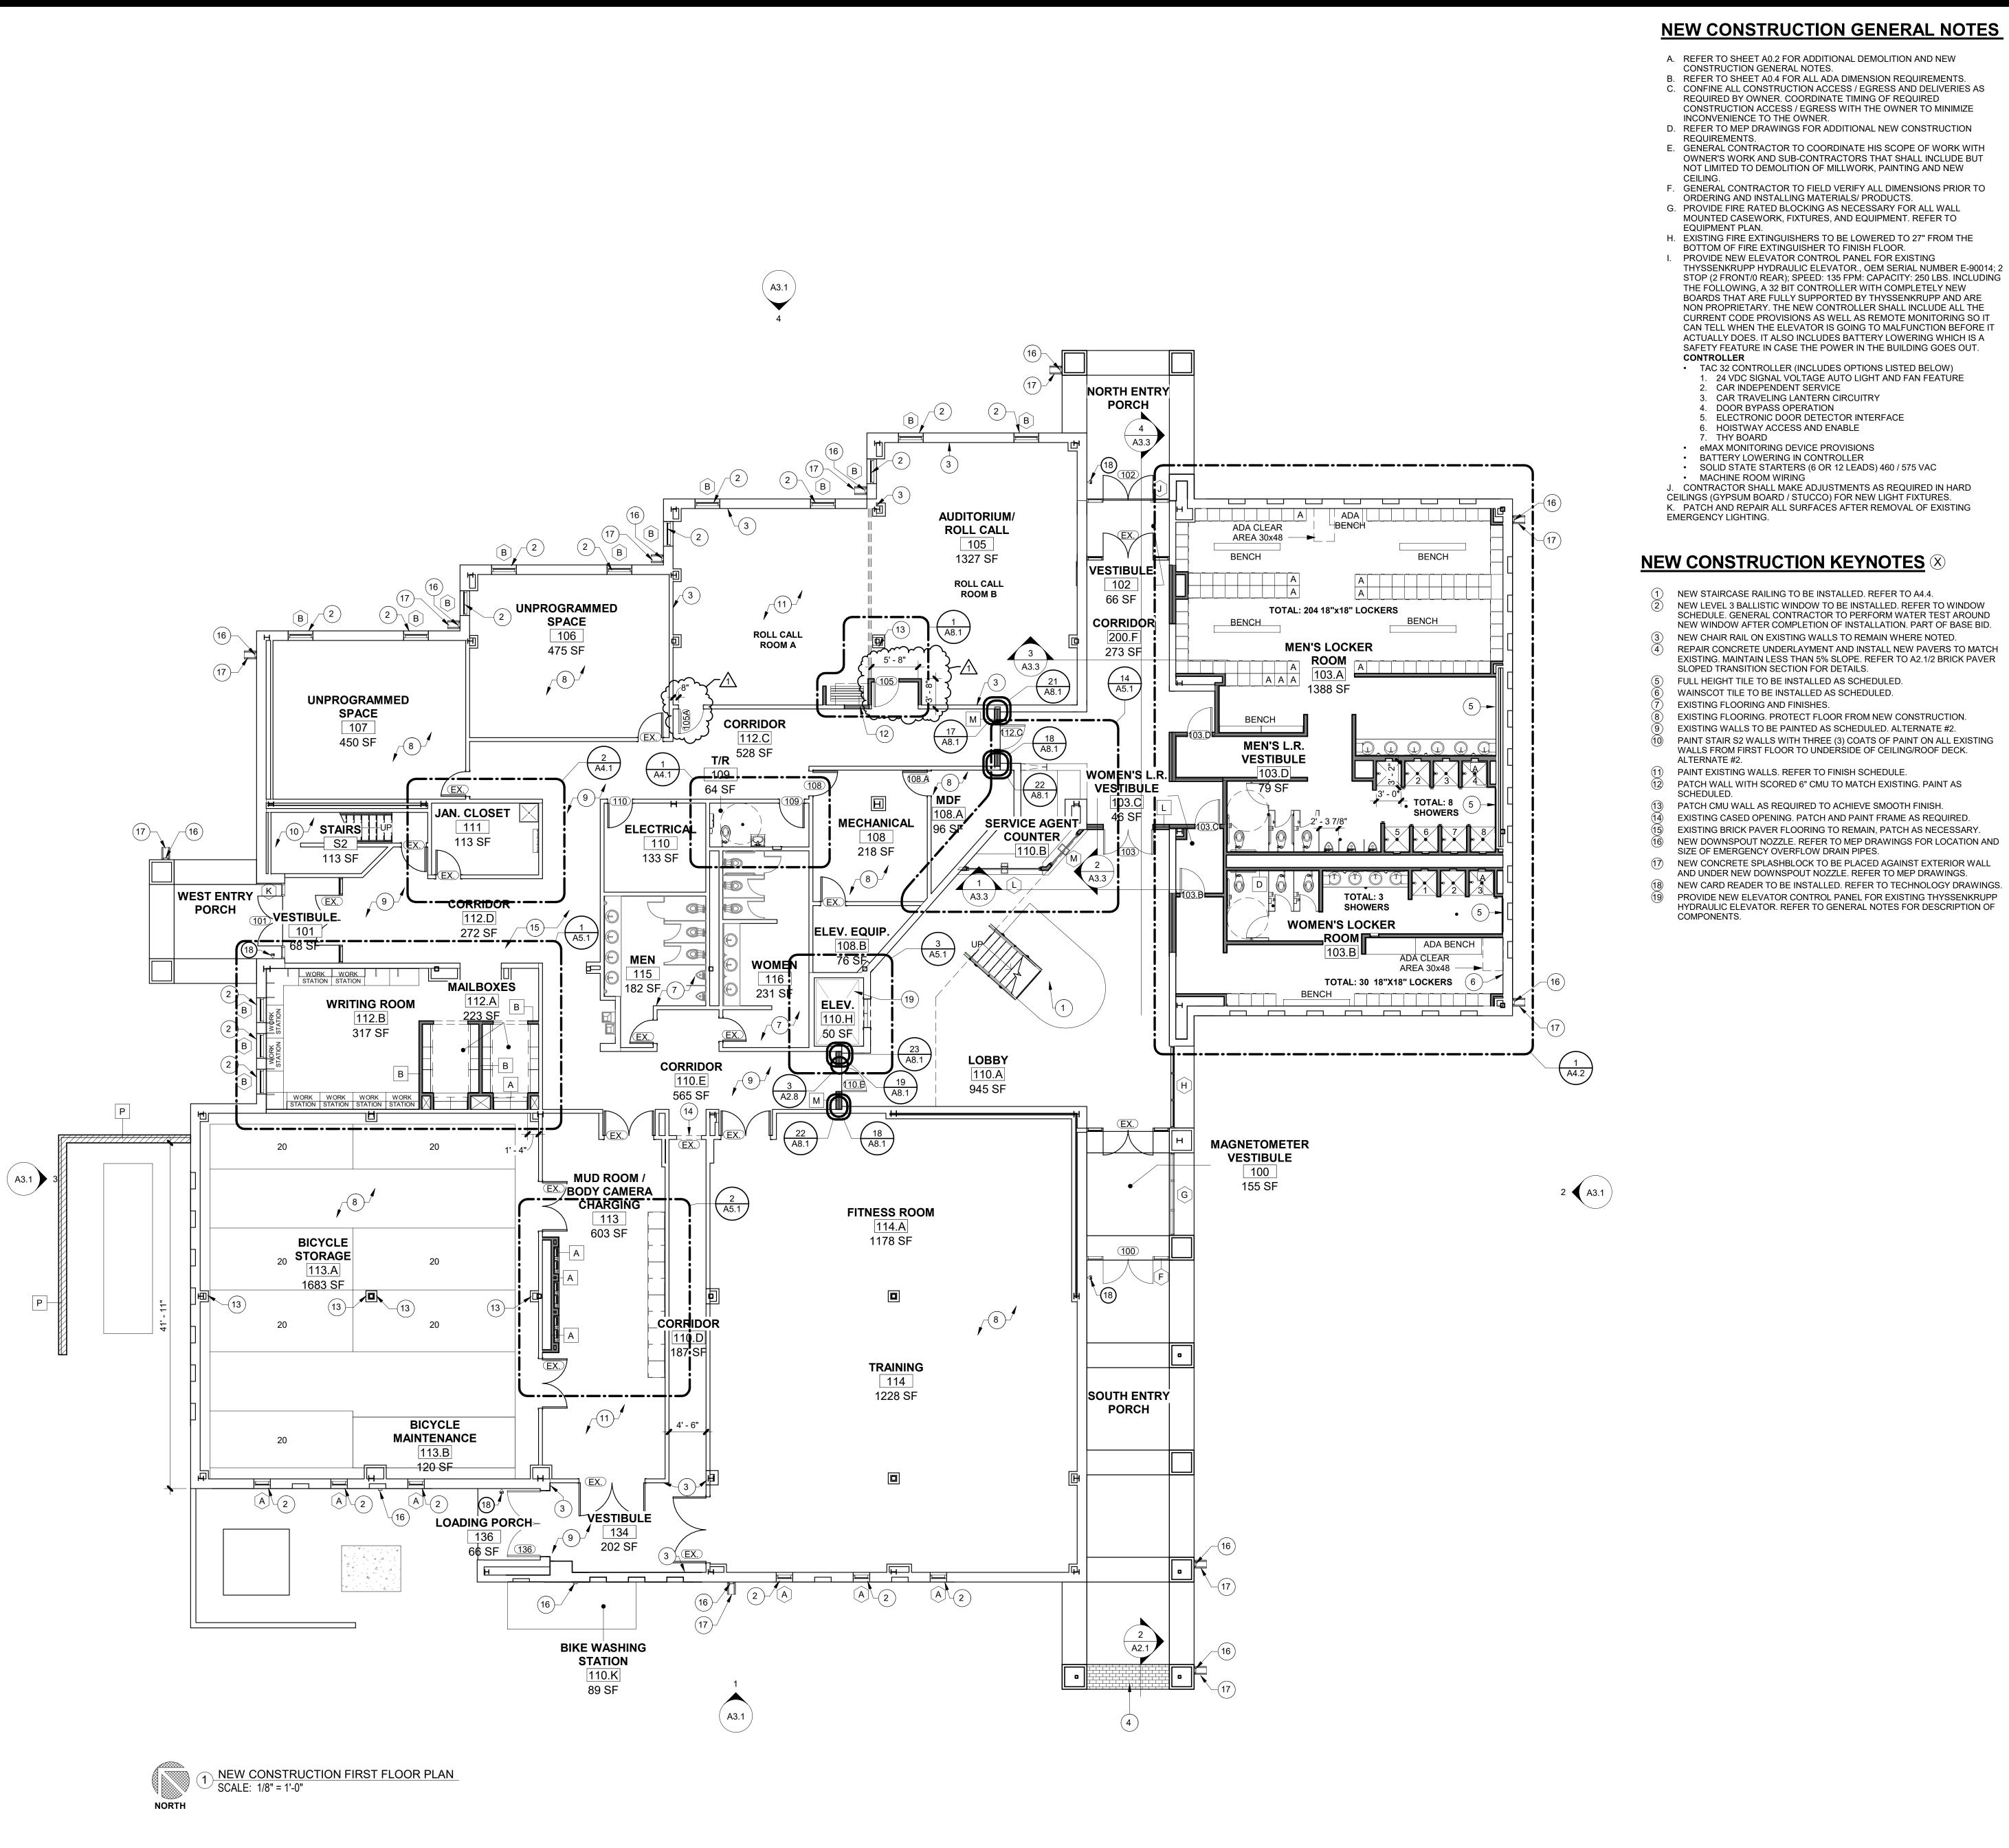

### **NEW CONSTRUCTION GENERAL NOTES**


- A. REFER TO SHEET A0.2 FOR ADDITIONAL DEMOLITION AND NEW CONSTRUCTION GENERAL NOTES.
- B. REFER TO SHEET A0.4 FOR ALL ADA DIMENSION REQUIREMENTS. C. CONFINE ALL CONSTRUCTION ACCESS / EGRESS AND DELIVERIES AS REQUIRED BY OWNER. COORDINATE TIMING OF REQUIRED
- CONSTRUCTION ACCESS / EGRESS WITH THE OWNER TO MINIMIZE INCONVENIENCE TO THE OWNER.
- D. REFER TO MEP DRAWINGS FOR ADDITIONAL NEW CONSTRUCTION REQUIREMENTS. E. GENERAL CONTRACTOR TO COORDINATE HIS SCOPE OF WORK WITH
- OWNER'S WORK AND SUB-CONTRACTORS THAT SHALL INCLUDE BUT NOT LIMITED TO DEMOLITION OF MILLWORK, PAINTING AND NEW
- F. GENERAL CONTRACTOR TO FIELD VERIFY ALL DIMENSIONS PRIOR TO ORDERING AND INSTALLING MATERIALS/ PRODUCTS. G. PROVIDE FIRE RATED BLOCKING AS NECESSARY FOR ALL WALL
- MOUNTED CASEWORK, FIXTURES, AND EQUIPMENT. REFER TO EQUIPMENT PLAN. H. EXISTING FIRE EXTINGUISHERS TO BE LOWERED TO 27" FROM THE BOTTOM OF FIRE EXTINGUISHER TO FINISH FLOOR. I. PROVIDE NEW ELEVATOR CONTROL PANEL FOR EXISTING
- BOARDS THAT ARE FULLY SUPPORTED BY THYSSENKRUPP AND ARE NON PROPRIETARY. THE NEW CONTROLLER SHALL INCLUDE ALL THE CURRENT CODE PROVISIONS AS WELL AS REMOTE MONITORING SO IT CAN TELL WHEN THE ELEVATOR IS GOING TO MALFUNCTION BEFORE IT ACTUALLY DOES, IT ALSO INCLUDES BATTERY LOWERING WHICH IS A
- SAFETY FEATURE IN CASE THE POWER IN THE BUILDING GOES OUT. CONTROLLER TAC 32 CONTROLLER (INCLUDES OPTIONS LISTED BELOW)
- 1. 24 VDC SIGNAL VOLTAGE AUTO LIGHT AND FAN FEATURE CAR INDEPENDENT SERVICE CAR TRAVELING LANTERN CIRCUITRY
- DOOR BYPASS OPERATION ELECTRONIC DOOR DETECTOR INTERFACE
- HOISTWAY ACCESS AND ENABLE THY BOARD eMAX MONITORING DEVICE PROVISIONS
- BATTERY LOWERING IN CONTROLLER SOLID STATE STARTERS (6 OR 12 LEADS) 460 / 575 VAC
- J. CONTRACTOR SHALL MAKE ADJUSTMENTS AS REQUIRED IN HARD CEILINGS (GYPSUM BOARD / STUCCO) FOR NEW LIGHT FIXTURES. K. PATCH AND REPAIR ALL SURFACES AFTER REMOVAL OF EXISTING


## **NEW CONSTRUCTION KEYNOTES (X)**


- NEW STAIRCASE RAILING TO BE INSTALLED. REFER TO A4.4. NEW LEVEL 3 BALLISTIC WINDOW TO BE INSTALLED. REFER TO WINDOW SCHEDULE. GENERAL CONTRACTOR TO PERFORM WATER TEST AROUND NEW WINDOW AFTER COMPLETION OF INSTALLATION. PART OF BASE BID.
- NEW CHAIR RAIL ON EXISTING WALLS TO REMAIN WHERE NOTED. REPAIR CONCRETE UNDERLAYMENT AND INSTALL NEW PAVERS TO MATCH EXISTING. MAINTAIN LESS THAN 5% SLOPE. REFER TO A2.1/2 BRICK PAVER SLOPED TRANSITION SECTION FOR DETAILS.
- FULL HEIGHT TILE TO BE INSTALLED AS SCHEDULED. WAINSCOT TILE TO BE INSTALLED AS SCHEDULED. EXISTING FLOORING AND FINISHES.
- EXISTING FLOORING. PROTECT FLOOR FROM NEW CONSTRUCTION. EXISTING WALLS TO BE PAINTED AS SCHEDULED. ALTERNATE #2.
- PAINT STAIR S2 WALLS WITH THREE (3) COATS OF PAINT ON ALL EXISTING WALLS FROM FIRST FLOOR TO UNDERSIDE OF CEILING/ROOF DECK. ALTERNATE #2.
- (11) PAINT EXISTING WALLS. REFER TO FINISH SCHEDULE. PATCH WALL WITH SCORED 6" CMU TO MATCH EXISTING. PAINT AS
- PATCH CMU WALL AS REQUIRED TO ACHIEVE SMOOTH FINISH. EXISTING CASED OPENING. PATCH AND PAINT FRAME AS REQUIRED.
- EXISTING BRICK PAVER FLOORING TO REMAIN, PATCH AS NECESSARY.
- NEW DOWNSPOUT NOZZLE. REFER TO MEP DRAWINGS FOR LOCATION AND SIZE OF EMERGENCY OVERFLOW DRAIN PIPES. NEW CONCRETE SPLASHBLOCK TO BE PLACED AGAINST EXTERIOR WALL
- AND UNDER NEW DOWNSPOUT NOZZLE. REFER TO MEP DRAWINGS. NEW CARD READER TO BE INSTALLED. REFER TO TECHNOLOGY DRAWINGS. PROVIDE NEW ELEVATOR CONTROL PANEL FOR EXISTING THYSSENKRUPP HYDRAULIC ELEVATOR. REFER TO GENERAL NOTES FOR DESCRIPTION OF


## NEW CONSTRUCTION LEGEND


EXISTING INTERIOR WALL TO REMAIN 5/8" GYP. BOARD ON ONE SIDE OF 3-5/8" METAL STUDS. EXTEND FROM FLOOR TO 6" ABOVE CEILING. REFER TO A2.6

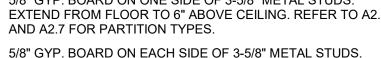

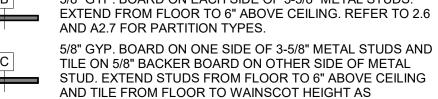

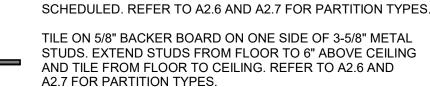

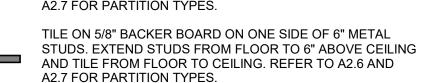

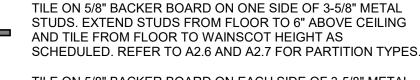

TILE ON 5/8" BACKER BOARD ON EACH SIDE OF 3-5/8" METAL STUDS. EXTEND TILE ON EACH SIDE TO CEILING. EXTEND STUDS FROM FLOOR TO 6" ABOVE CEILING. REFER TO A2.6 AND A2.7 FOR PARTITION TYPES.

TILE ON 5/8" BACKER BOARD ON EACH SIDE OF 6" METAL STUDS. EXTEND TILE ON EACH SIDE TO CEILING. EXTEND STUDS FROM FLOOR TO 6" ABOVE CEILING. REFER TO A2.6 AND A2.7 FOR PARTITION TYPES.

TILE ON 5/8" BACKER BOARD ON EACH SIDE OF 3-5/8" METAL STUDS. EXTEND TILE ON ONE SIDE TO CEILING AND ON OTHER TO WAINSCOT HEIGHT AS SCHEDULED. EXTEND STUDS FROM FLOOR TO 6" ABOVE CEILING. REFER TO A2.6 AND A2.7 FOR PARTITION TYPES.

> TILE ON 5/8" BACKER BOARD ON EACH SIDE OF 3-5/8" METAL STUDS. EXTEND TILE ON EACH SIDE TO WAINSCOT HEIGHT AS SCHEDULED. EXTEND STUDS FROM FLOOR TO 6" ABOVE CEILING. REFER TO A2.6 AND A2.7 FOR PARTITION TYPES.

ONE LAYER OF SPECIAL BRICK (8x4x8) UP TO 4'-8" A.F.F. WITH WOOD BLOCKING AND GYPSUM BOARD REVEAL AS SPECIFIED ABOVE, WITH 3 5/8" METAL STUD WITH 5/8" GYPSUM BOARD ON ONE SIDE WITH REVEALS AS SPECIFIED ABOVE. 1 1/2" METAL HAT CHANNELS WITH 5/8" BACKER BOARD AND TILE FROM FLOOR TO CEILING LEVEL ON OTHER SIDE. REFER TO A2.6 AND A2.7 FOR PARTITION

ONE LAYER OF SPECIAL BRICK (8x4x8) UP TO 4'-8" A.F.F. WITH WOOD BLOCKING AND GYPSUM BOARD REVEAL AS SPECIFIED ABOVE, WITH 3 5/8" METAL STUD WITH 5/8" GYPSUM BOARD ON ONE SIDE WITH REVEALS AS SPECIFIED ABOVE SPECIAL BRICK. 1 1/2" METAL HAT CHANNELS WITH 5/8" BACKER BOARD AND TILE FROM FLOOR TO CEILING LEVEL ON OTHER SIDE. REFER TO A2.6 AND A2.7 FOR PARTITION TYPES.

ONE LAYER OF SPECIAL BRICK (8x4x8) UP TO 4'-8" A.F.F. WITH WOOD BLOCKING ABOVE AND GYPSUM BOARD REVEAL AS SPECIFIED, WITH 3 5/8" METAL STUD WITH 5/8" GYPSUM BOARD ON ONE SIDE WITH REVEALS AS SPECIFIED ABOVE. 1 1/2" METAL HAT CHANNELS WITH 5/8" BACKER BOARD AND TILE FROM FLOOR TO WAINSCOT HEIGHT AS SPECIFIED ON OTHER SIDE. REFER TO A2.6 AND A2.7 FOR

TWO LAYERS OF SPECIAL BRICK (8x4x8) UP TO 4'-8" A.F.F. WITH WOOD BLOCKING ABOVE AND GYPSUM BOARD REVEAL AS SPECIFIED, WITH 6" METAL STUD WITH 5/8" GYPSUM BOARD ABOVE WOOD BLOCKING WITH REVEALS AS SPECIFIED. LEVEL 1 BALLISTIC FIBERGLASS PANELS WITH 4" WIDE BATTEN AT EACH SEAM UP TO 8'-0" A.F.F., 1/4" PLYWOOD STARTING AT 8'-0" A.F.F. AND UP ON ONE SIDE. 5/8" GYPSUM BOARD AS SPECIFIED ON ONE SIDE ABOVE THE 3" WOOD BLOCKING WITH GYPSUM BOARD. REFER TO A2.6 AND A2.7 FOR PARTITION TYPES.

ONE LAYER OF SPECIAL BRICK (8x4x8) UP TO 4'-8" A.F.F. WITH WOOD BLOCKING AND GYPSUM BOARD REVEAL AS SPECIFIED ABOVE, WITH 3 5/8" METAL STUD WITH 5/8" GYPSUM BOARD ON ONE SIDE WITH REVEALS AS SPECIFIED ABOVE SPECIAL BRICK. ONE LAYER OF 4" SCORED CMU TO FLOOR TO CEILING LEVEL ON OTHER SIDE. REFER TO A2.6 AND A2.7 FOR PARTITION TYPES.

5/8" BACKER BOARD AND TILE AS SCHEDULED FROM FINISH FLOOR TO CEILING ON EXISTING 4" CMU.REFER TO A2.6 AND A2.7 FOR PARTITION TYPES.

NEW 6" SCORED CMU TO MATCH EXISTING ADJACENT. REFER TO A2.6 AND A2.7 FOR PARTITION TYPES.

ONE LAYER OF SPECIAL BRICK (8x4x8) WITH 8" CMU WITH REINFORCEMENT AS SPECIFIED. REFER TO A2.6 AND A2.7 FOR PARTITION TYPES. EXISTING DOOR TO REMAIN

NEW DOOR. REFER TO DOOR SCHEDULE ON SHEET A2.7

NEW WINDOW. REFER TO WINDOW SCHEDULE ON SHEETS A2.8 AND A2.9

(X) → SYMBOL INDICATES NEW KEYNOTE NEW ADA LOCKER AS SCHEDULED

NEW ADA SHOWER. REFER TO MEP DRAWINGS

**Revision Schedule** 

Description Date

ADD #01 5/3/2021





JOB NO: DATE: DRAWN BY:

> CHECKED BY: SHEET A2.2

**NEW CONSTRUCTION FIRST** FLOOR PLAN

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## **NEW CONSTRUCTION GENERAL NOTES**


- A. REFER TO SHEET A0.2 FOR ADDITIONAL DEMOLITION AND NEW
- CONSTRUCTION GENERAL NOTES. B. REFER TO SHEET A0.4 FOR ALL ADA DIMENSION REQUIREMENTS. C. CONFINE ALL CONSTRUCTION ACCESS / EGRESS AND DELIVERIES AS REQUIRED BY OWNER. COORDINATE TIMING OF REQUIRED CONSTRUCTION ACCESS / EGRESS WITH THE OWNER TO MINIMIZE
- INCONVENIENCE TO THE OWNER. D. REFER TO MEP DRAWINGS FOR ADDITIONAL NEW CONSTRUCTION
- E. GENERAL CONTRACTOR TO COORDINATE HIS SCOPE OF WORK WITH OWNER'S WORK AND SUB-CONTRACTORS THAT SHALL INCLUDE BUT NOT LIMITED TO DEMOLITION OF MILLWORK, PAINTING AND NEW
- F. GENERAL CONTRACTOR TO FIELD VERIFY ALL DIMENSIONS PRIOR TO ORDERING AND INSTALLING MATERIALS/ PRODUCTS.
- G. PROVIDE FIRE RATED BLOCKING AS NECESSARY FOR ALL WALL MOUNTED CASEWORK, FIXTURES, AND EQUIPMENT. REFER TO
- EQUIPMENT PLAN. H. EXISTING FIRE EXTINGUISHERS TO BE LOWERED TO 27" FROM THE
- BOTTOM OF FIRE EXTINGUISHER TO FINISH FLOOR. I. PROVIDE NEW ELEVATOR CONTROL PANEL FOR EXISTING THYSSENKRUPP HYDRAULIC ELEVATOR., OEM SERIAL NUMBER E-90014; 2 STOP (2 FRONT/0 REAR); SPEED: 135 FPM: CAPACITY: 250 LBS. INCLUDING THE FOLLOWING, A 32 BIT CONTROLLER WITH COMPLETELY NEW BOARDS THAT ARE FULLY SUPPORTED BY THYSSENKRUPP AND ARE NON PROPRIETARY. THE NEW CONTROLLER SHALL INCLUDE ALL THE CURRENT CODE PROVISIONS AS WELL AS REMOTE MONITORING SO IT CAN TELL WHEN THE ELEVATOR IS GOING TO MALFUNCTION BEFORE IT ACTUALLY DOES. IT ALSO INCLUDES BATTERY LOWERING WHICH IS A SAFETY FEATURE IN CASE THE POWER IN THE BUILDING GOES OUT.
- TAC 32 CONTROLLER (INCLUDES OPTIONS LISTED BELOW) 1. 24 VDC SIGNAL VOLTAGE AUTO LIGHT AND FAN FEATURE
- . CAR INDEPENDENT SERVICE . CAR TRAVELING LANTERN CIRCUITRY
- 4. DOOR BYPASS OPERATION 5. ELECTRONIC DOOR DETECTOR INTERFACE
- 6. HOISTWAY ACCESS AND ENABLE 7. THY BOARD
- eMAX MONITORING DEVICE PROVISIONS BATTERY LOWERING IN CONTROLLER SOLID STATE STARTERS (6 OR 12 LEADS) 460 / 575 VAC
- MACHINE ROOM WIRING J. CONTRACTOR SHALL MAKE ADJUSTMENTS AS REQUIRED IN HARD CEILINGS (GYPSUM BOARD / STUCCO) FOR NEW LIGHT FIXTURES. K. PATCH AND REPAIR ALL SURFACES AFTER REMOVAL OF EXISTING


## NEW CONSTRUCTION LEGEND

EXISTING INTERIOR WALL TO REMAIN

5/8" GYP. BOARD ON ONE SIDE OF 3-5/8" METAL STUDS AND TILE ON 5/8" BACKER BOARD ON OTHER SIDE OF METAL STUD. EXTEND STUDS FROM FLOOR TO 6" ABOVE CEILING AND TILE FROM FLOOR TO WAINSCOT HEIGHT AS SCHEDULED. REFER TO A2.6 AND A2.6b FOR PARTITION



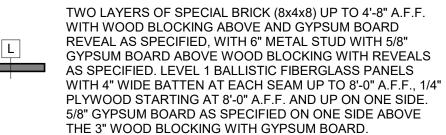


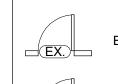


EXISTING DOOR TO REMAIN



NEW WINDOW. REFER TO WINDOW SCHEDULE ON SHEETS

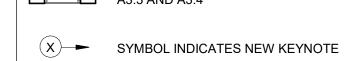

□□□□□ A3.3 AND A3.4

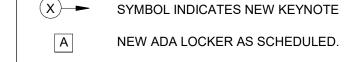

NEW ADA SHOWER. REFER TO MEP DRAWINGS.

### **NEW CONSTRUCTION KEYNOTES ®**

- NEW STAIRCASE RAILING TO BE INSTALLED. REFER TO A4.4. EXISTING FLOORING. PROTECT FLOOR FROM NEW CONSTRUCTION.
- PAINT EXISTING AND NEW WALLS AS SCHEDULED. REFER TO A11.1 FOR PAINT LOCATIONS.
- NEW PROJECTOR SCREEN TO BE INSTALLED. OWNER PROVIDED. EXISTING WINDOW TO BE CAULKED AS REQUIRED. GENERAL CONTRACTOR TO PERFORM WATER TEST AROUND EXISTING WINDOWS AFTER

NEW FLOORING AND BASE AS SCHEDULED. REFER TO A11.1 FOR DETAILS.

- COMPLETION OF SEALING WORK. PART OF BASE BID. EXISTING FLOORING AND FINISHES.
- NEW LEVEL 3 BALLISTIC WINDOW TO BE INSTALLED. REFER TO WINDOW SCHEDULE. GENERAL CONTRACTOR TO PERFORM WATER TEST AROUND NEW WINDOW AFTER COMPLETION OF INSTALLATION. PART OF BASE BID.
- NEW FINISHES AS SCHEDULED. NEW CEILING TO BE INSTALLED. ALTERNATE #3.
- EXISTING EQUIPMENT CONCRETE PAD. EXISTING CASEWORK.
- PAINT STAIR S2 WALLS WITH THREE (3) COATS OF PAINT ON ALL EXISTING WALLS FROM FIRST FLOOR TO UNDERSIDE OF CEILING/ROOF DECK. ALTERNATE #2.
- 13) PROVIDE NEW ELEVATOR CONTROL PANEL FOR EXISTING THYSSENKRUPP HYDRAULIC ELEVATOR. REFER TO GENERAL NOTES FOR DESCRIPTION OF



Revision Schedule

Description Date

ADD #01 5/3/2021

JOB NO: DATE: 05/03/2021 DRAWN BY: CHECKED BY:

SHEET A2.3

**EXHIBIT I** 

**NEW CONSTRUCTION** SECOND FLOOR PLAN

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## **NEW CONSTRUCTION GENERAL NOTES**


- A. REFER TO SHEET A0.2 FOR ADDITIONAL DEMOLITION AND NEW CONSTRUCTION GENERAL NOTES.
  B. REFER TO SHEET A0.4 FOR ALL ADA DIMENSION REQUIREMENTS. C. CONFINE ALL CONSTRUCTION ACCESS / EGRESS AND DELIVERIES AS REQUIRED BY OWNER. COORDINATE TIMING OF REQUIRED CONSTRUCTION ACCESS / EGRESS WITH THE OWNER TO MINIMIZE
- INCONVENIENCE TO THE OWNER.

  D. REFER TO MEP DRAWINGS FOR ADDITIONAL NEW CONSTRUCTION REQUIREMENTS.
- E. GENERAL CONTRACTOR TO COORDINATE HIS SCOPE OF WORK WITH OWNER'S WORK AND SUB-CONTRACTORS THAT SHALL INCLUDE BUT NOT LIMITED TO DEMOLITION OF MILLWORK, PAINTING AND NEW
- CEILING.

  F. GENERAL CONTRACTOR TO FIELD VERIFY ALL DIMENSIONS PRIOR TO ORDERING AND INSTALLING MATERIALS/ PRODUCTS.

  G. PROVIDE FIRE RATED BLOCKING AS NECESSARY FOR ALL WALL MOUNTED CASEWORK, FIXTURES, AND EQUIPMENT. REFER TO
- EQUIPMENT PLAN.


  H. EXISTING FIRE EXTINGUISHERS TO BE LOWERED TO 27" FROM THE BOTTOM OF FIRE EXTINGUISHER TO FINISH FLOOR.

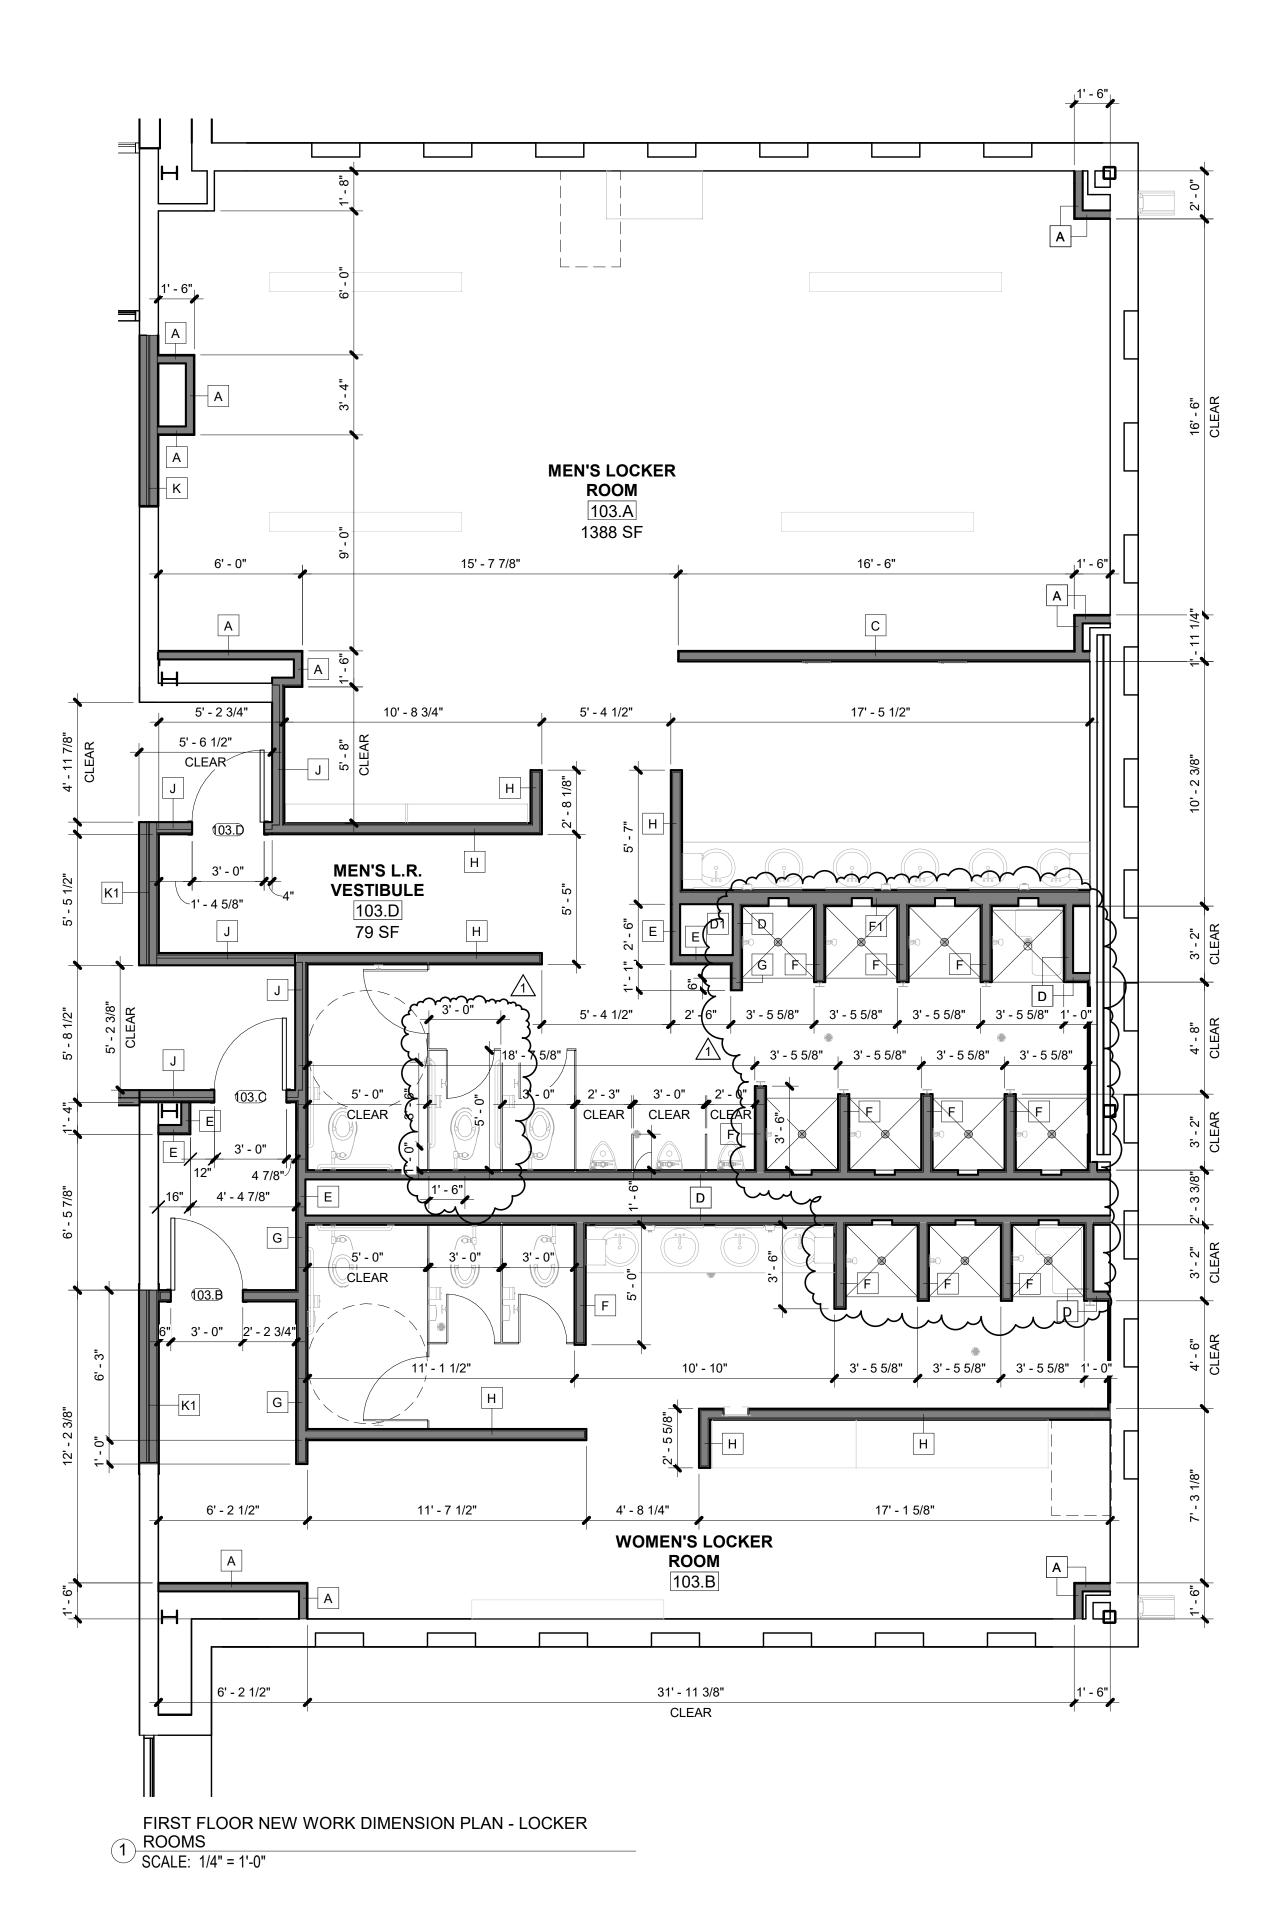

# **EXHIBIT J**

# FIRST FLOOR NEW WORK **DIMENSION PLAN**

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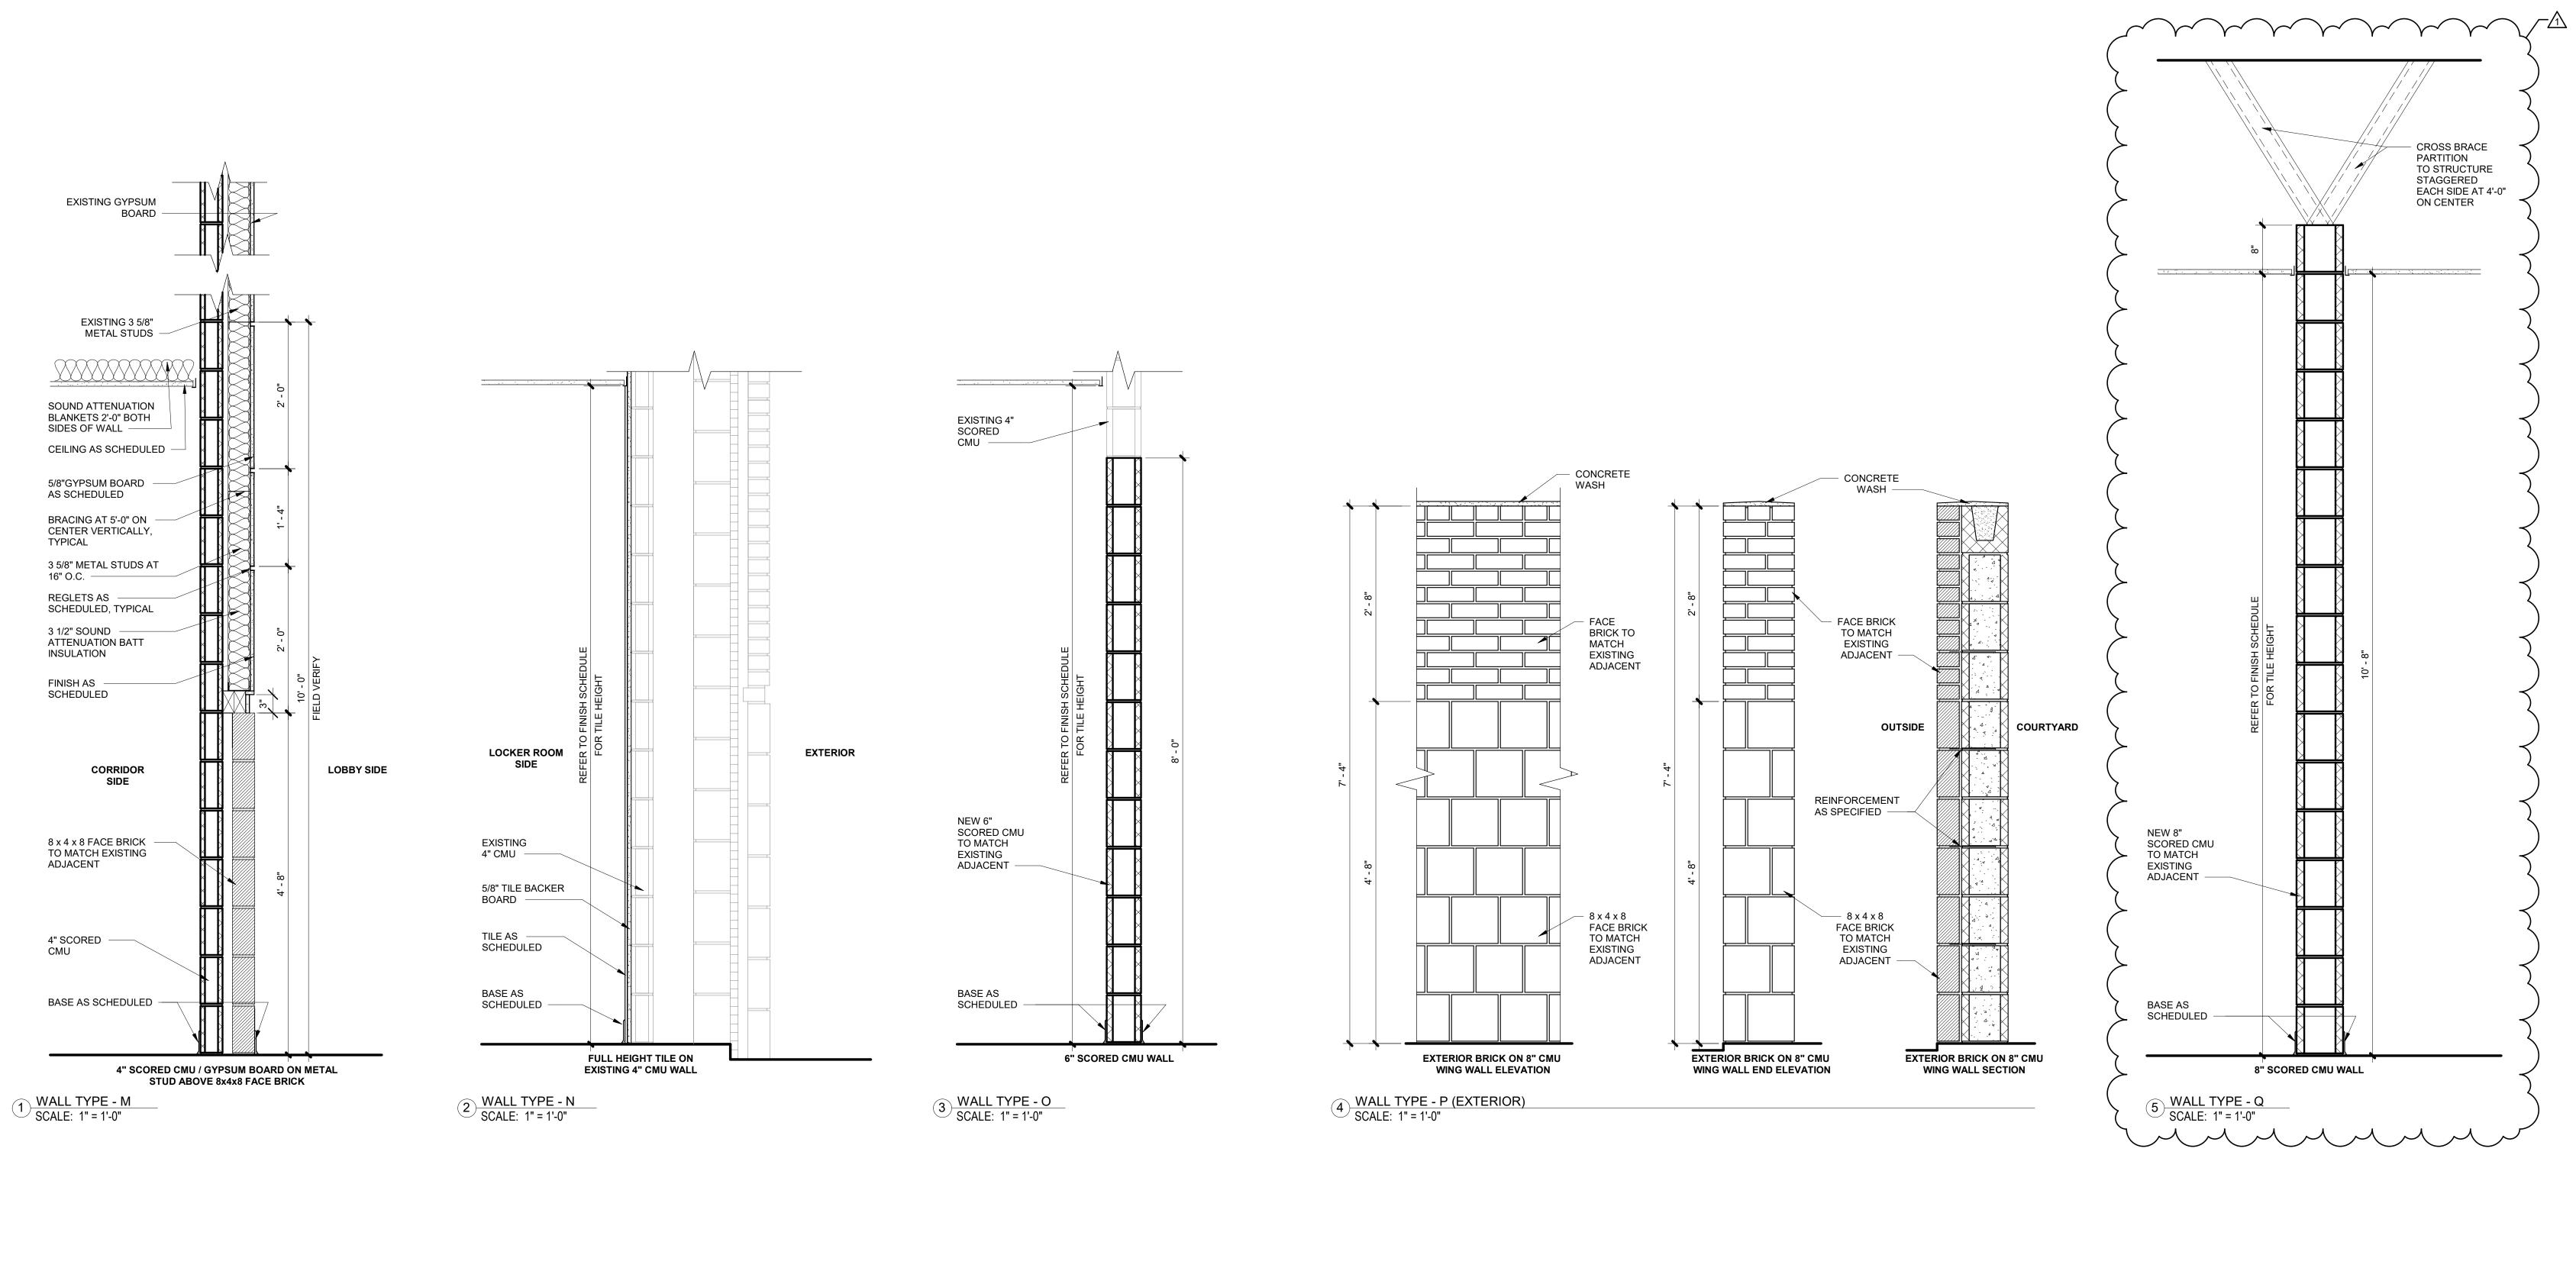


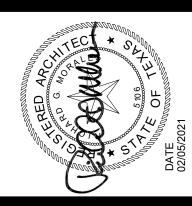**Revision Schedule** Description Date ADD #01 5/3/2021





JOB NO: DATE: 02/05/2021 DRAWN BY: CHECKED BY: RM



PARK PC

**Revision Schedule** 

DescriptionDateADD #015/3/2021





ralespartners,inc.
:hitecture/interior design
4901 Broadway, Suite 250 | San Antonio, Texas 78209
0.828.9481 v | 210.828.9719 f | TBAE Firm Reg BR1010
chesneymorales.com

Chesneymord

archite

archite

210.828

JOB NO: 1653.G

DATE: 05/03/2021


DRAWN BY: GF

CHECKED BY: RM

A2.7

**EXHIBIT K** 

PARTITION TYPES

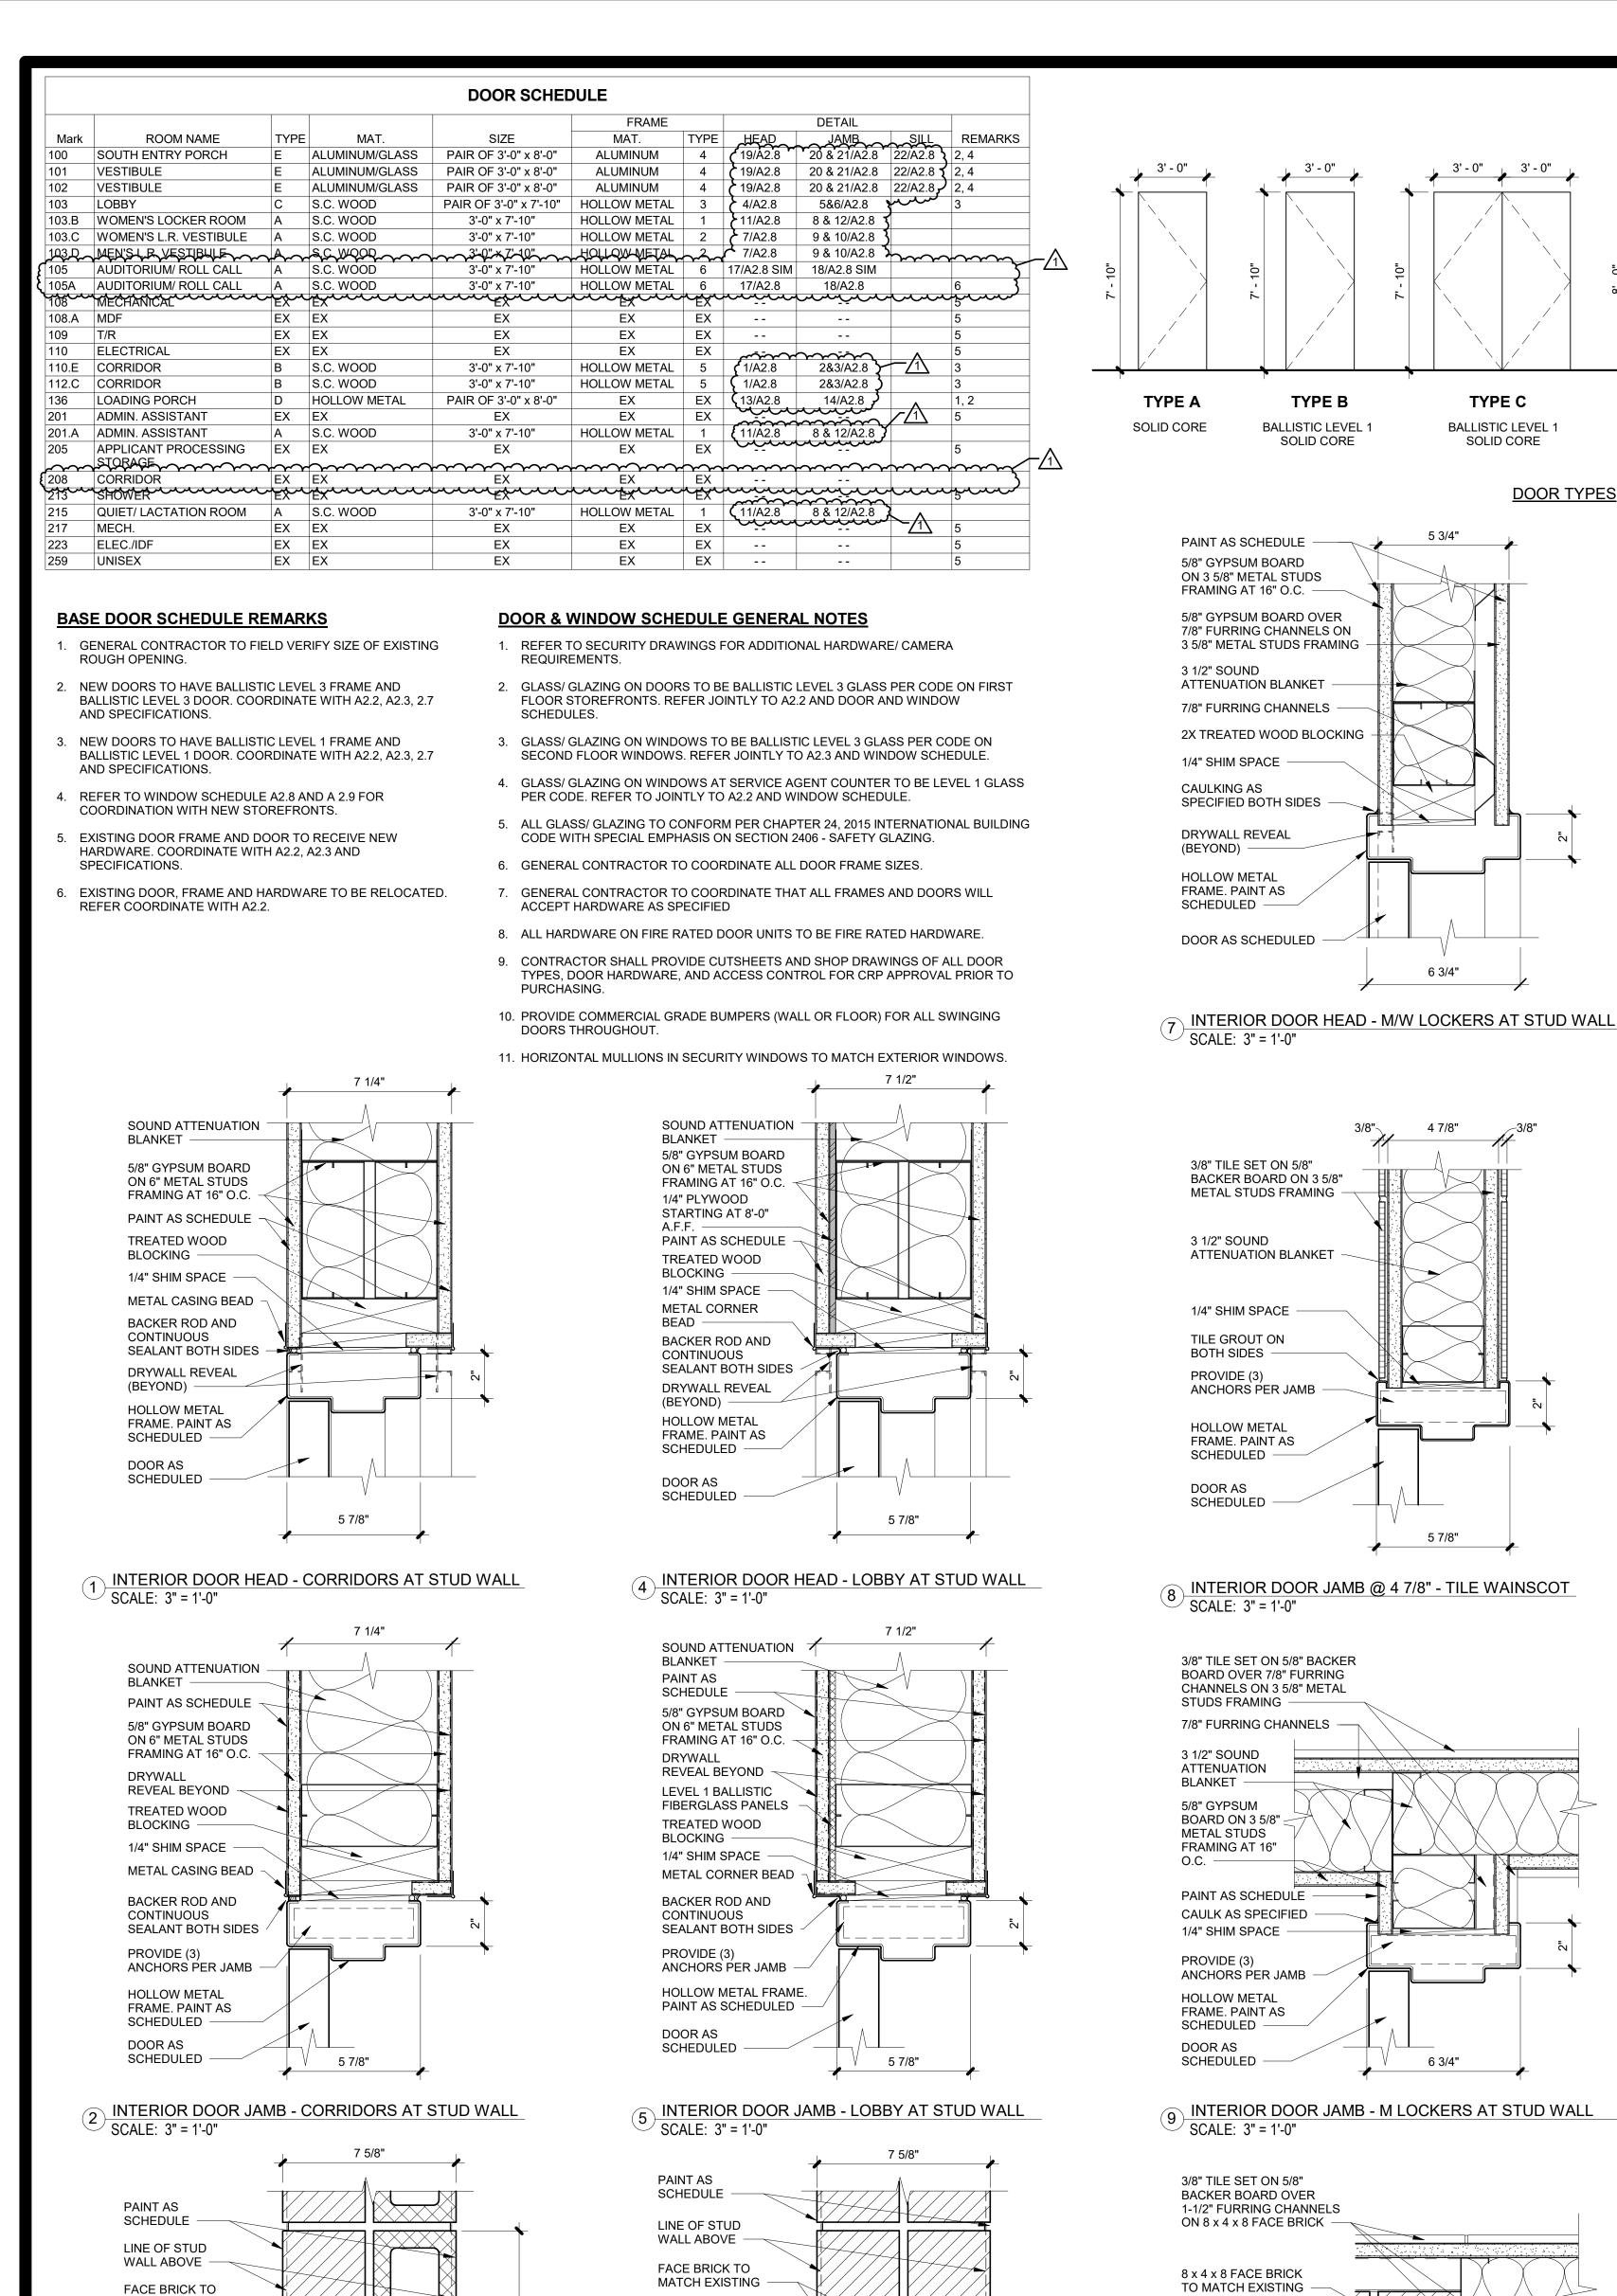

1/4" SHIM SPACE

BACKER ROD AND

SEALANT BOTH SIDES

ANCHORS PER JAMB

5 7/8"

NITERIOR DOOR JAMB - LOBBY AT BRICK WALL

CONTINUOUS

PROVIDE (3)

**HOLLOW METAL** 

SCHEDULED -

DOOR AS

SCHEDULED

FRAME. PAINT AS

MATCH EXISTING

1/4" SHIM SPACE

BACKER ROD AND

SEALANT BOTH SIDES

ANCHORS PER JAMB

5 7/8"

 $_{\wedge}$  INTERIOR DOOR JAMB - CORRIDORS AT BRICK WALL

CONTINUOUS

PROVIDE (3)


**HOLLOW METAL** 

SCHEDULED -

SCHEDULED

DOOR AS

FRAME. PAINT AS

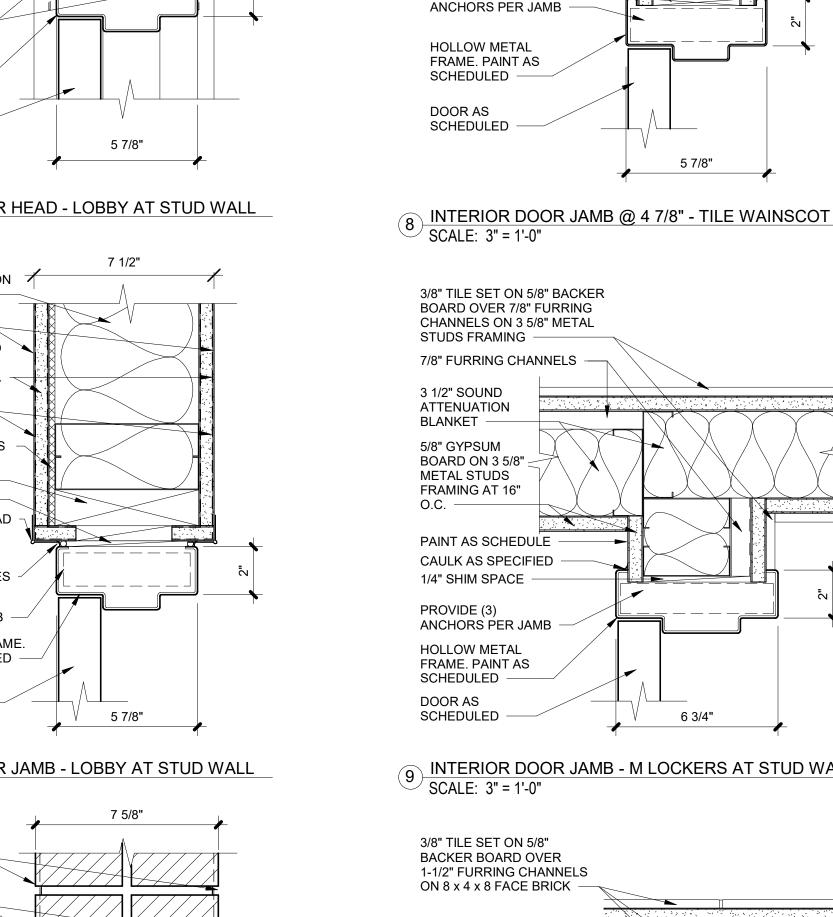

TYPE B

**BALLISTIC LEVEL 1** 

SOLID CORE

TYPE C

BALLISTIC LEVEL 1

SOLID CORE

6 3/4"

4 7/8"

3/8" TILE SET ON 5/8"

3 1/2" SOUND

1/4" SHIM SPACE -

TILE GROUT ON

BOTH SIDES -

PROVIDE (3)

BACKER BOARD ON 3 5/8"

METAL STUDS FRAMING

ATTENUATION BLANKET

**DOOR TYPES** 

TYPE D

BALLISTIC LEVEL 3

HOLLOW METAL DOOR

PAINT AS SCHEDULED

PAINT AS SCHEDULE -

5/8" GYPSUM BOARD ON

ATTENUATION BLANKET

CAULK ON BOTH SIDES

ANCHORS PER JAMB

BOTH SIDES

3 1/2" SOUND

PROVIDE (3)

**HOLLOW METAL** 

SCHEDULED -

DOOR AS

SCHEDULED

3 1/2" SOUND

ATTENUATION BLANKET

3/8" TILE SET ON 5/8'

BACKER BOARD

7/8" FURRING

3 1/2" SOUND

5/8" GYPSUM

BOARD ON 3 5/8"

METAL STUDS

FRAMING AT 16"

PAINT AS SCHEDULE

CAULK AS SPECIFIED -

ANCHORS PER JAMB -

1/4" SHIM SPACE -

PROVIDE (3)

**HOLLOW METAL** 

FRAME. PAINT AS


ATTENUATION


CHANNELS

BLANKET

FRAME. PAINT AS

1/4" SHIM SPACE

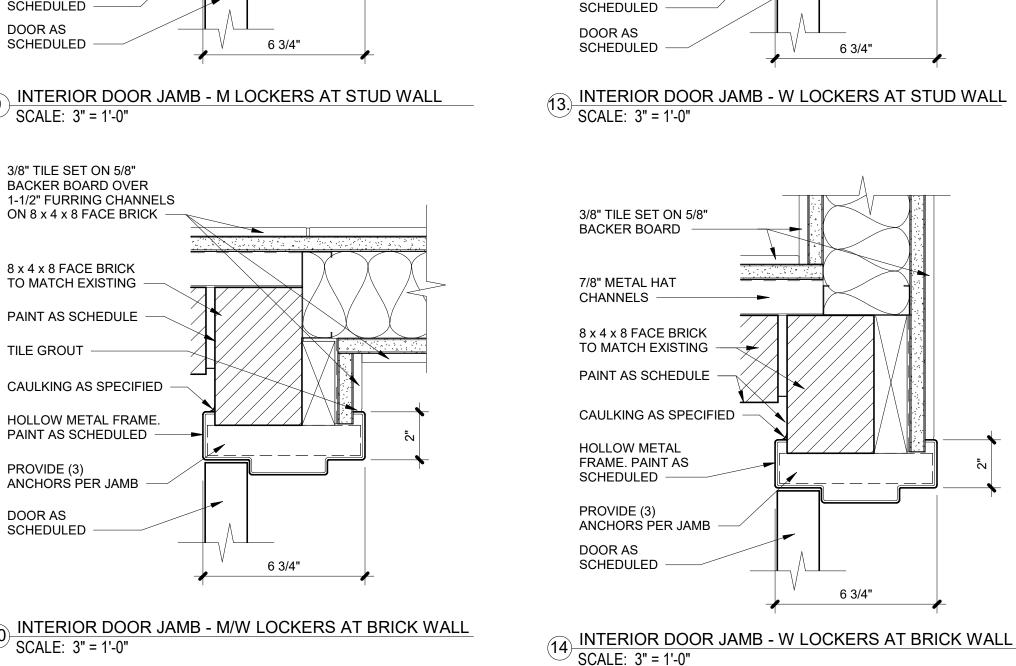

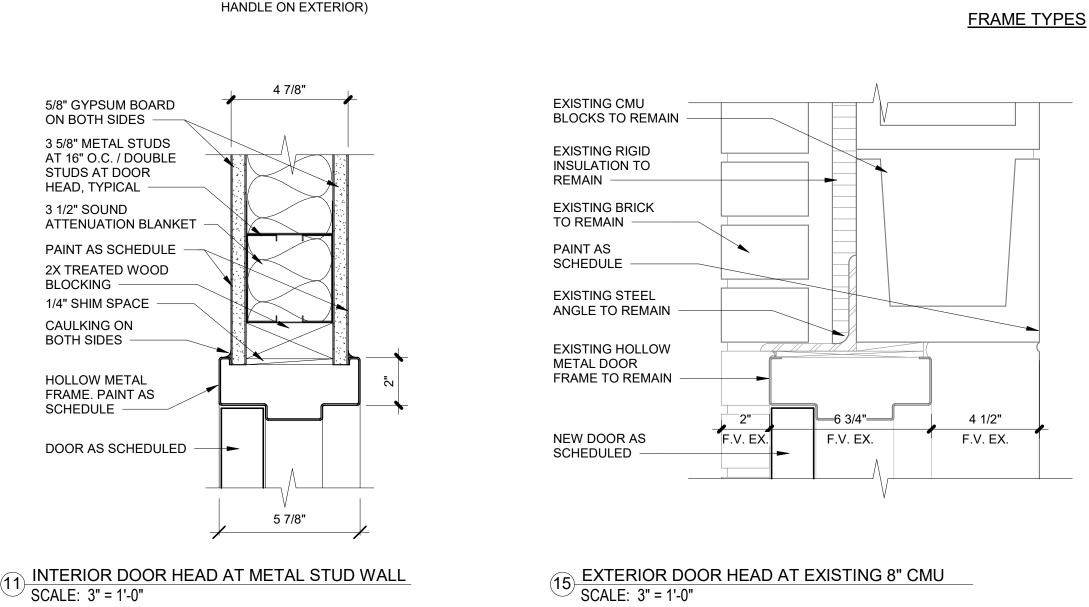

A2.8

2"—DOOR WIDTH

**HOLLOW METAL** 

5-7/8" JAMB DEPTH

SINGLE FRAME

A2.8

FRAME 2

**HOLLOW METAL** 

6-3/4" JAMB DEPTH

SINGLE FRAME

A2.8

A2.8

TYPE E

BALLISTIC LEVEL 3

ALUMINUM DOOR WITH

INTEGRATED REMOVABLE MULLION

(PANIC BAR IN INTERIOR & PULL

5 7/8"

6 3/4"

12 INTERIOR DOOR JAMB AT METAL STUD WALL

DOOR WIDTH

FRAME 3

LEVEL 1 BALLISTIC

**HOLLOW METAL** 

5-7/8" JAMB DEPTH

DOUBLE FRAME

A2.8

EXTERIOR

SCALE: 3" = 1'-0"

ALUMINUM STOREFRONT

LEVEL 3 BALLISTIC

FRAMING SYSTEM -

LEVEL 3

BALLISTIC

GLAZING

SCALE: 3" = 1'-0"

FRAME 4


LEVEL 3 BALLISTIC ALUMINUM


FRAME. REMOVABLE CENTER

ALUMINUM MULLION

(EXTERIOR DOORS ONLY)

A2.8

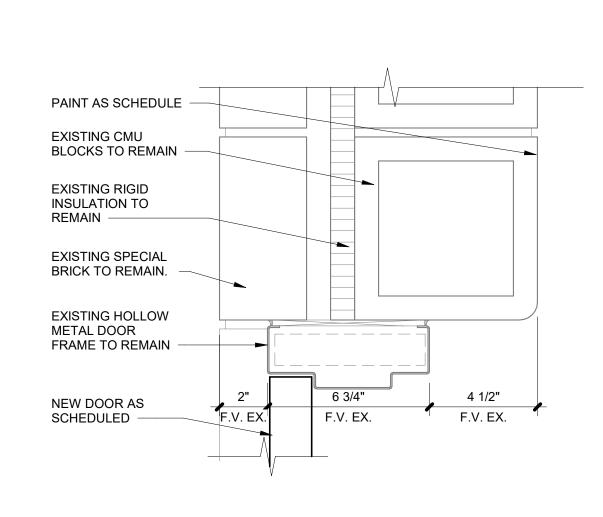

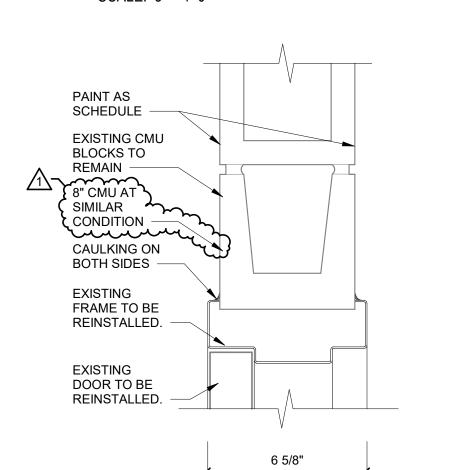

BOTH SIDES

FRAME TO BE

REINSTALLED.

**EXISTING** 


**EXISTING** 

DOOR TO BE

REINSTALLED


SCALE: 3" = 1'-0"

EXTERIOR DOOR JAMB AT EXISTING 8" CMU

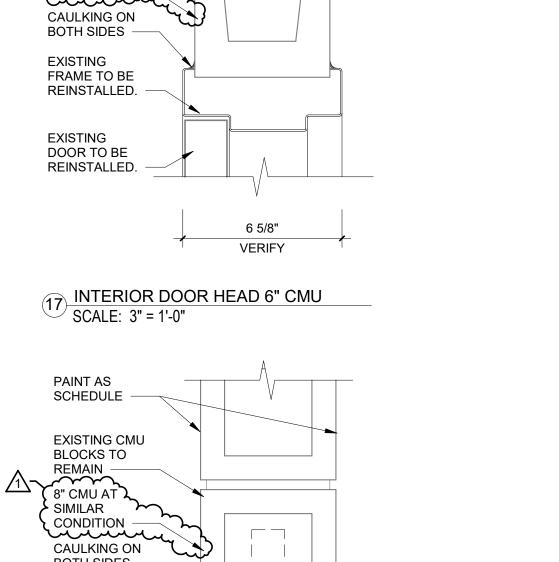

6 3/4"

INTERIOR DOOR JAMB 6" CMU

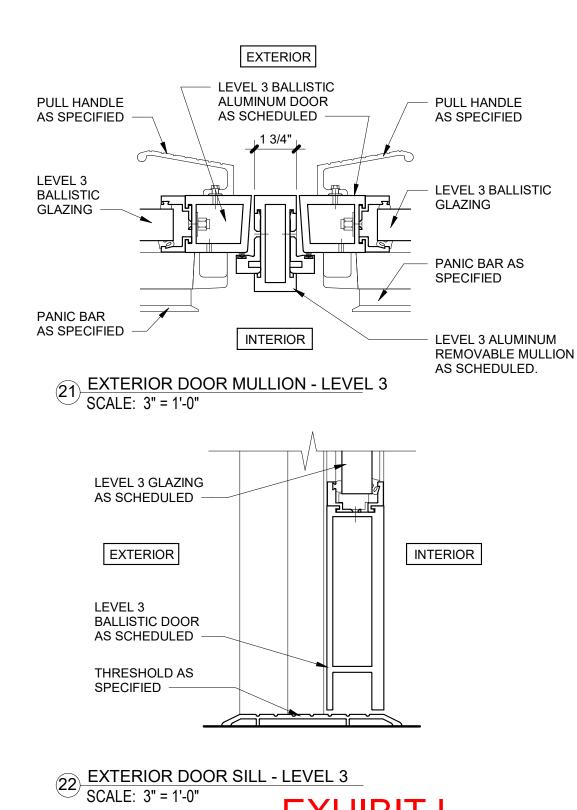



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**Revision Schedule** Description ADD #01 5/3/2021

FRAME 6 **HOLLOW METAL** 6-3/4" JAMB DEPTH SINGLE FRAME

A2.8

A2.8

FRAME 5

LEVEL 1 BALLISTIC

**HOLLOW METAL** 

4-3/4" JAMB DEPTH

SINGLE FRAME

LEVEL 3 BALLISTIC

LEVEL 3 BALLISTIC

FRAMING SYSTEM

 LEVEL 3 BALLISTIC ALUMINUM DOOR

AS SCHEDULED

LEVEL 3 BALLISTIC

LEVEL 3 BALLISTIC

**ALUMINUM DOOR** 

LEVEL 3 BALLISTIC

AS SCHEDULED

GLAZING

- PANIC BAR AS

SPECIFIED

GLAZING

INTERIOR

EXTERIOR STOREFRONT DOOR HEADER - LEVEL 3

EXTERIOR


INTERIOR

20 EXTERIOR STOREFRONT DOOR JAMB - LEVEL 3

GLAZING

ALUMINUM

STOREFRONT

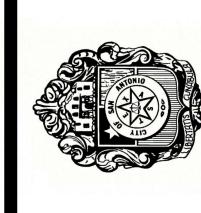

JOB NO: 1653.G 05/03/2021 DRAWN BY: CHECKED BY:

		ALTERNATE	WINDOW	SCHEDULE					
TYPE	FRAME MATERIAL	GLAZING MATERIAL	SIZE	BALLISTIC LEVEL	HEADER DTL.	JAMB DTL.	SILL DTL.	QTY.	REMARI
D	ALUMINUM	1" INSULATED GLAZING	36" x 40"	N/A	1/A3.3	4/A2.8	5/A2.8	4	1, 2, 3
E	ALUMINUM	1" INSULATED GLAZING	36" x 63"	N/A	1/A3.3	4/A2.8	5/A2.8	27	1, 2, 3

### **ALTERNATE WINDOW SCHEDULE REMARKS**


- 1. GENERAL CONTRACTOR TO FIELD VERIFY SIZE OF EXISTING ROUGH OPENING
- 2. ALTERNATE NO. 3: ALL EXISTING WINDOWS ON THE SECOND FLOOR TO BE REPLACED WITH NEW ALUMINUM FRAME, 1" INSULATED WINDOWS WITH SEALANT ON EACH SIDE AS SPECIFIED. COORDINATE WITH A2.3, A3.3 AND SPECIFICATIONS.
- 3. CONTRACTOR TO PERFORM WATER TEST AROUND NEW WINDOWS AT COMPLETION OF INSTALLATION. PART OF ALTERNATE #3.


### **DOOR & WINDOW SCHEDULE GENERAL NOTES**

- 1. REFER TO SECURITY DRAWINGS FOR ADDITIONAL HARDWARE/ CAMERA REQUIREMENTS.
- GLASS/ GLAZING ON DOORS TO BE BALLISTIC LEVEL 3 GLASS PER CODE ON FIRST FLOOR STOREFRONTS. REFER JOINTLY TO A2.2 AND DOOR AND WINDOW SCHEDULES.
- 3. GLASS/ GLAZING ON WINDOWS TO BE BALLISTIC LEVEL 3 GLASS PER CODE ON SECOND FLOOR WINDOWS. REFER JOINTLY TO A2.3 AND WINDOW SCHEDULE.
- 4. GLASS/ GLAZING ON WINDOWS AT SERVICE AGENT COUNTER TO BE LEVEL 1 GLASS PER CODE. REFER TO JOINTLY TO A2.2 AND WINDOW SCHEDULE
- 5. ALL GLASS/ GLAZING TO CONFORM PER CHAPTER 24, 2015 INTERNATIONAL BUILDING CODE WITH SPECIAL EMPHASIS ON SECTION 2406 - SAFETY GLAZING.
- 6. GENERAL CONTRACTOR TO COORDINATE ALL DOOR FRAME SIZES.
- 7. GENERAL CONTRACTOR TO COORDINATE THAT ALL FRAMES AND DOORS WILL ACCEPT HARDWARE AS SPECIFIED
- 8. ALL HARDWARE ON FIRE RATED DOOR UNITS TO BE FIRE RATED HARDWARE. 9. CONTRACTOR SHALL PROVIDE CUTSHEETS AND SHOP DRAWINGS OF ALL DOOR
- TYPES, DOOR HARDWARE, AND ACCESS CONTROL FOR CRP APPROVAL PRIOR TO
- 10. PROVIDE COMMERCIAL GRADE BUMPERS (WALL OR FLOOR) FOR ALL SWINGING DOORS THROUGHOUT.
- 11. HORIZONTAL MULLIONS IN SECURITY WINDOWS TO MATCH EXTERIOR WINDOWS.

INTERIOR EXTERIOR LEVEL 3 LEVEL 3 BALLISTIC BALLISTIC ALUMINUM MUNTIN GLAZING

MUNTIN - HORIZONTAL INTERMEDIATE (TYPICAL) SCALE: 3" = 1'-0"

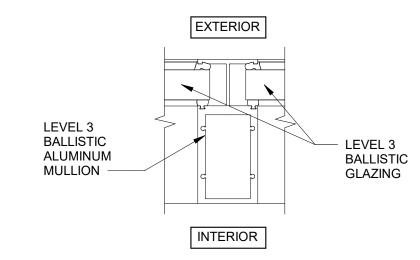

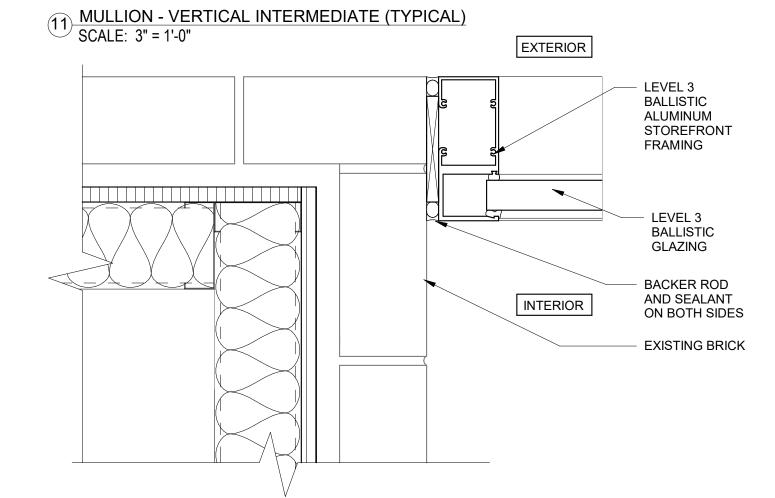

STOREFRONT WINDOW JAMB AT SOUTH ENTRANCE (TYPE E, F & G) SCALE: 3" = 1'-0"

**Revision Schedule** 

Description

ADD #02 5/14/2021


JOB NO: 05/03/2021 DATE: DRAWN BY:

SHEET

CHECKED BY:



WINDOW SCHEDULE & **DETAILS** 

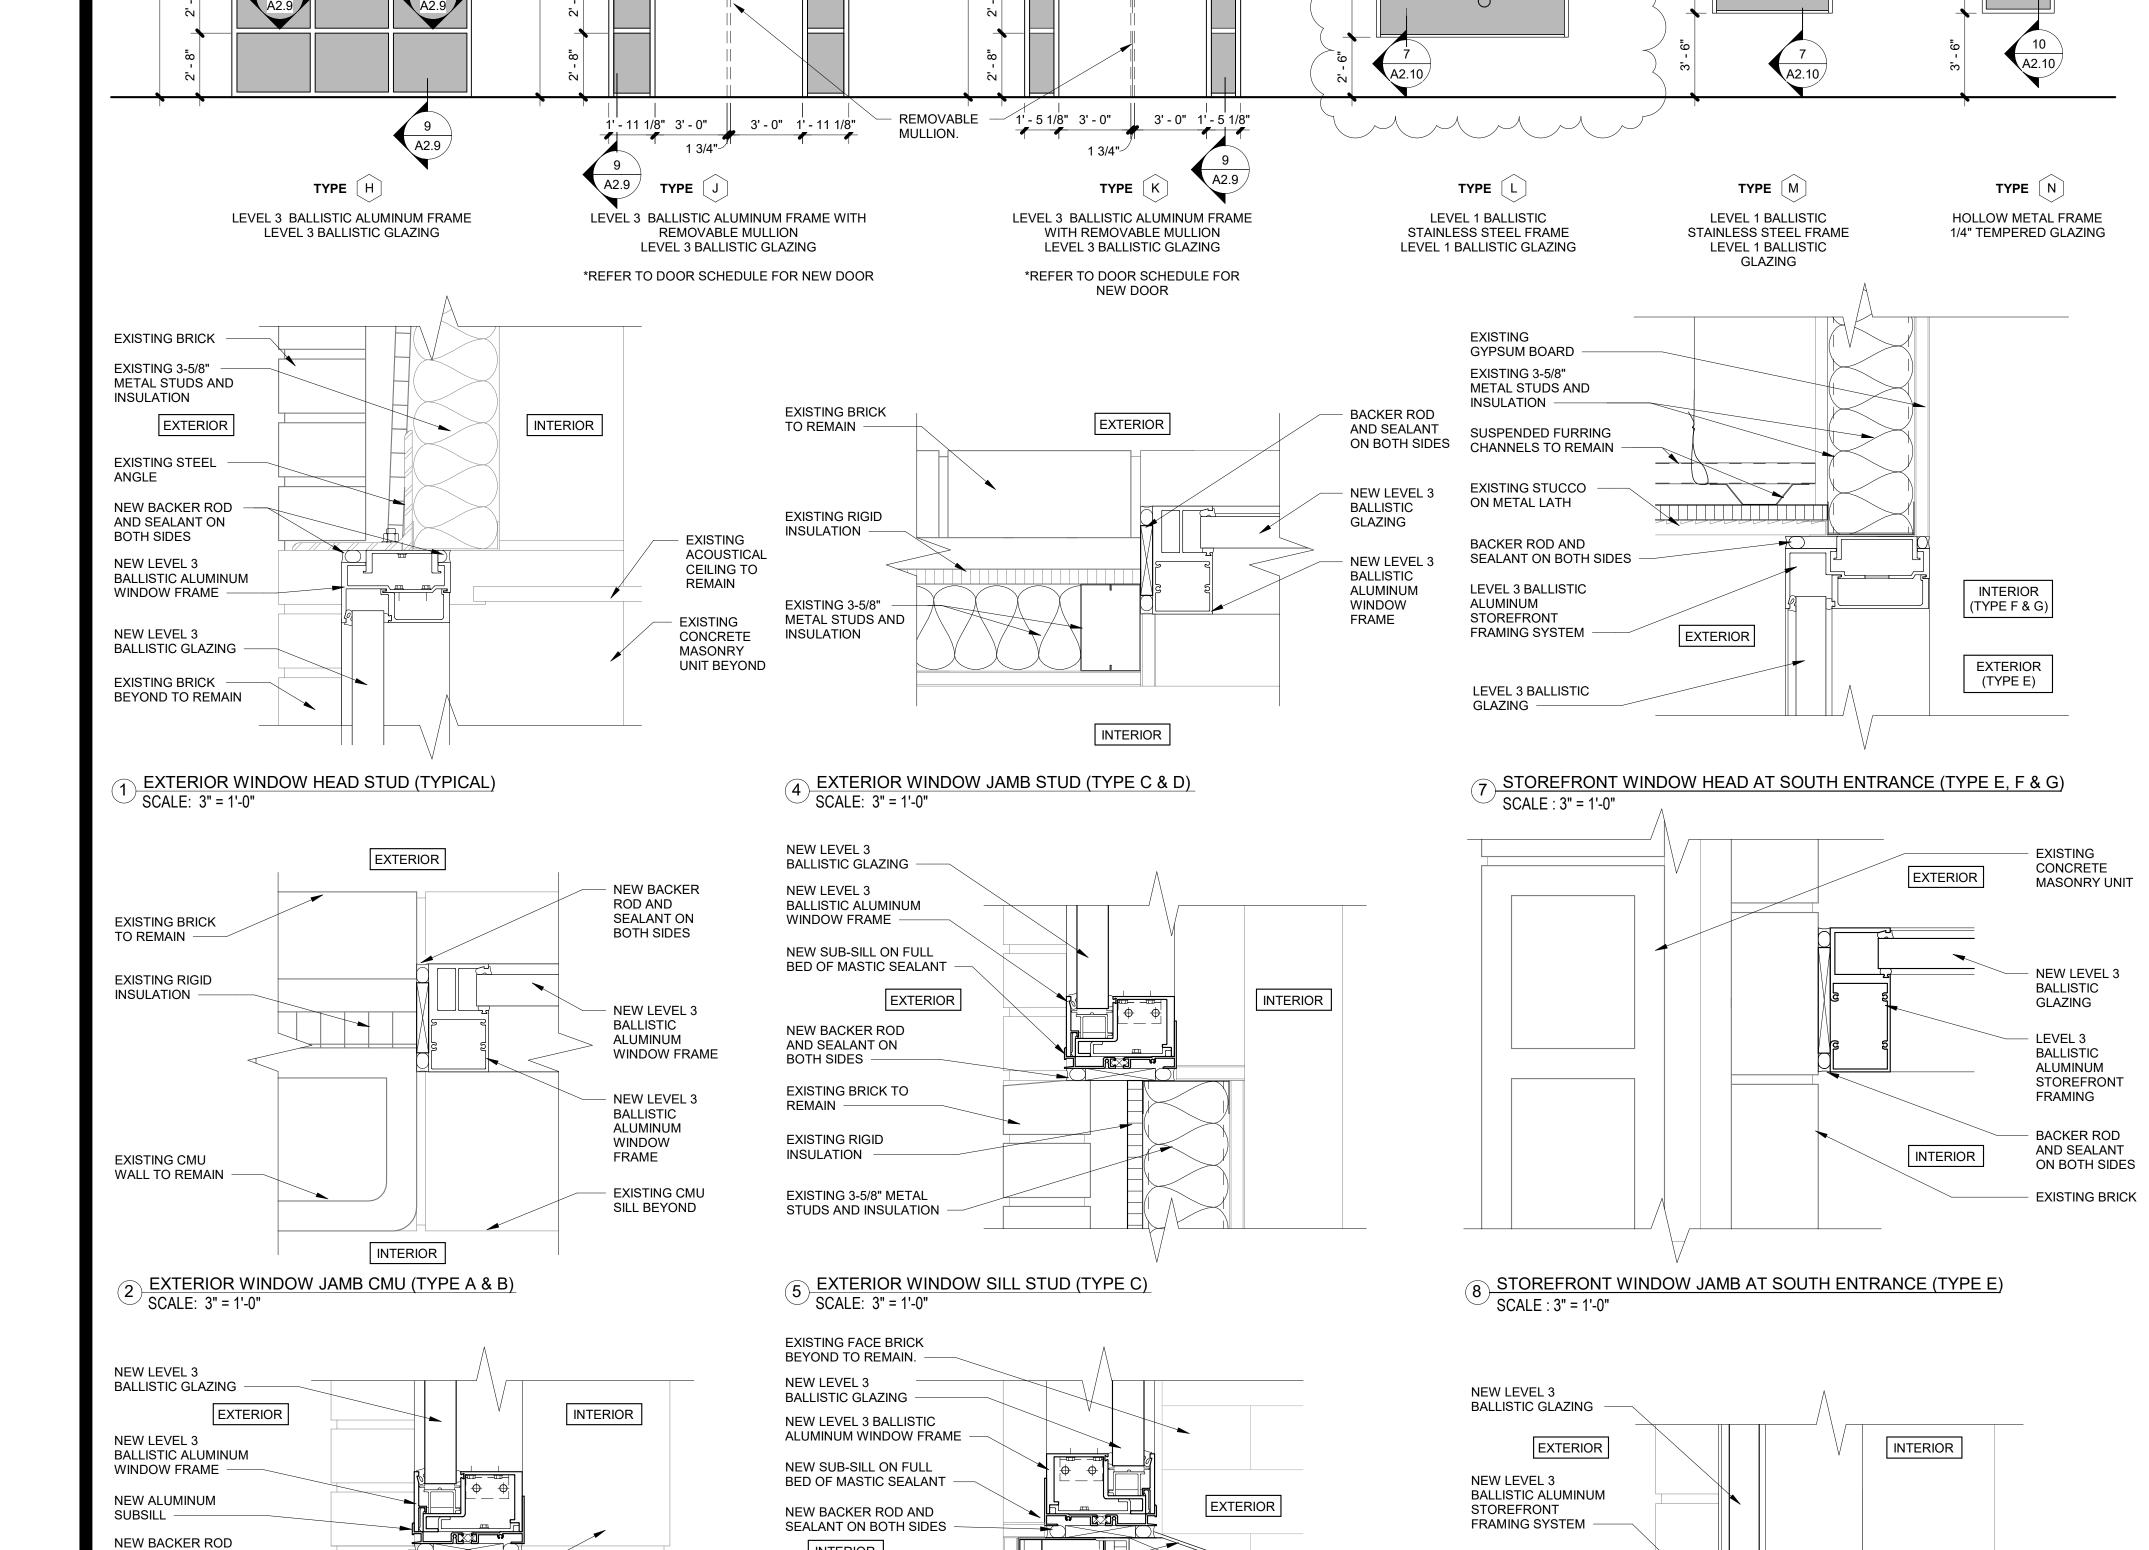

INTERIOR

WOOD BLOCKING

EXISTING 3-5/8"

EXISTING 3-5/8"

METAL STUDS AND

METAL STUD -

INSULATION -

NEW METAL CHANNEL.

PAINTED AS SCHEDULED.

SCALE: 3" = 1'-0"

6 CLERESTORY WINDOW SILL (TYPE D)

REMOVABLE

LEVEL 3 BALLISTIC ALUMINUM FRAME

WITH REMOVABLE MULLION

LEVEL 3 BALLISTIC GLAZING

\*REFER TO DOOR SCHEDULE FOR

NEW SUB-SILL ON

**NEW BACKER ROD** 

AND SEALANT ON BOTH SIDES -

EXISTING FOUNDATION

SCALE: 3" = 1'-0"

9 STOREFRONT WINDOW SILL (TYPICAL)

SEALANT

TO REMAIN

FULL BED OF MASTIC

NEW DOOR.

LEVEL 3 BALLISTIC ALUMINUM FRAME

LEVEL 3 BALLISTIC GLAZING

TYPE [E]

SECOND FLOOR

& GLAZING

EXISTING ALUMINUM FRAME

(ALT. NO. 3)

1" INSULATED GLAZING

ALUMINUM FRAME

**SECOND FLOOR** 

EXISTING ALUMINUM

FRAME & GLAZING

6' - 1 3/4"

(ALT. NO. 3)

ALUMINUM FRAME

1" INSULATED GLAZING

A2.9 /

FIRST FLOOR

LEVEL 3 BALLISTIC

ALUMINUM FRAME

GLAZING

LEVEL 3 BALLISTIC

AND SEALANT ON BOTH SIDES -

EXISTING BRICK TO

EXISTING CMU WALL

INSULATION TO REMAIN

SCALE: 3" = 1'-0"

EXTERIOR WINDOW SILL CMU (TYPE A & B)

**EXISTING RIGID** 

TO REMAIN

REMAIN

FIRST FLOOR

ALUMINUM FRAME

GLAZING

LEVEL 3 BALLISTIC

 LEVEL 3 BALLISTIC GLAZING

ALUMINUM FRAME

LEVEL 3 BALLISTIC

LEVEL 3 BALLISTIC

9' - 11 3/4"


3' - 3 1/8" 3' - 3 1/8" 3' - 2 7/8"

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		TOILE	ET ACCESS	ORIES SCHEDULE
TAG	DESCRIPTION	MANUFACTURER	MODEL	REMARKS
TA-1	36" GRAB BAR	BOBRICK	B-6806-36	33"-36" A.F.F. TO TOP OF BAR. REFER TO SHEET A0.4 FOR INSTALLATION REQUIREMENTS.
TA-2	42" GRAB BAR	BOBRICK	B-6806-42	
TA-3	TOILET PAPER DISPENSER	GEORGIA PACIFIC	59209	REFER TO SHEET A0.4 FOR INSTALLATION REQUIREMENTS.
TA-4	SOAP DISPENSER	GEORGIA PACIFIC	52057	
TA-5	MIRROR (24"X36")	BOBRICK	B-165-2436	40" TO BOTTOM REFLECTIVE SURFACE. REFER TO SHEET A0.4 FOR INSTALLATION REQUIREMENTS.
TA-6	SURFACE MOUNTED PAPER TOWEL DISPENSER	GEORGIA PACIFIC	59590	
TA-7	RECESSED WASTE RECEPTACLE	BOBRICK	B-35633	
TA-8	SANITARY NAPKIN DISPOSAL	BOBRICK	B-270	
TA-9	SHOWER CURTAIN ROD	BOBRICK	B-207	
TA-10	MOP/ BROOM HOLDER	BOBRICK	B-239 x 34	
TA-11	ADA SHOWER SEAT	BOBRICK	B-5181	
TA-12	SHOWER CURTAIN	BOBRICK	204.2	
TA-13	SURFACE MOUNTED TOWEL HOOK	BOBRICK	B-7671	


8 UNISEX 259 - NORTH SCALE: 1/4" = 1'-0"

7 SHOWER 213 - WEST ELEVATION SCALE: 1/4" = 1'-0"

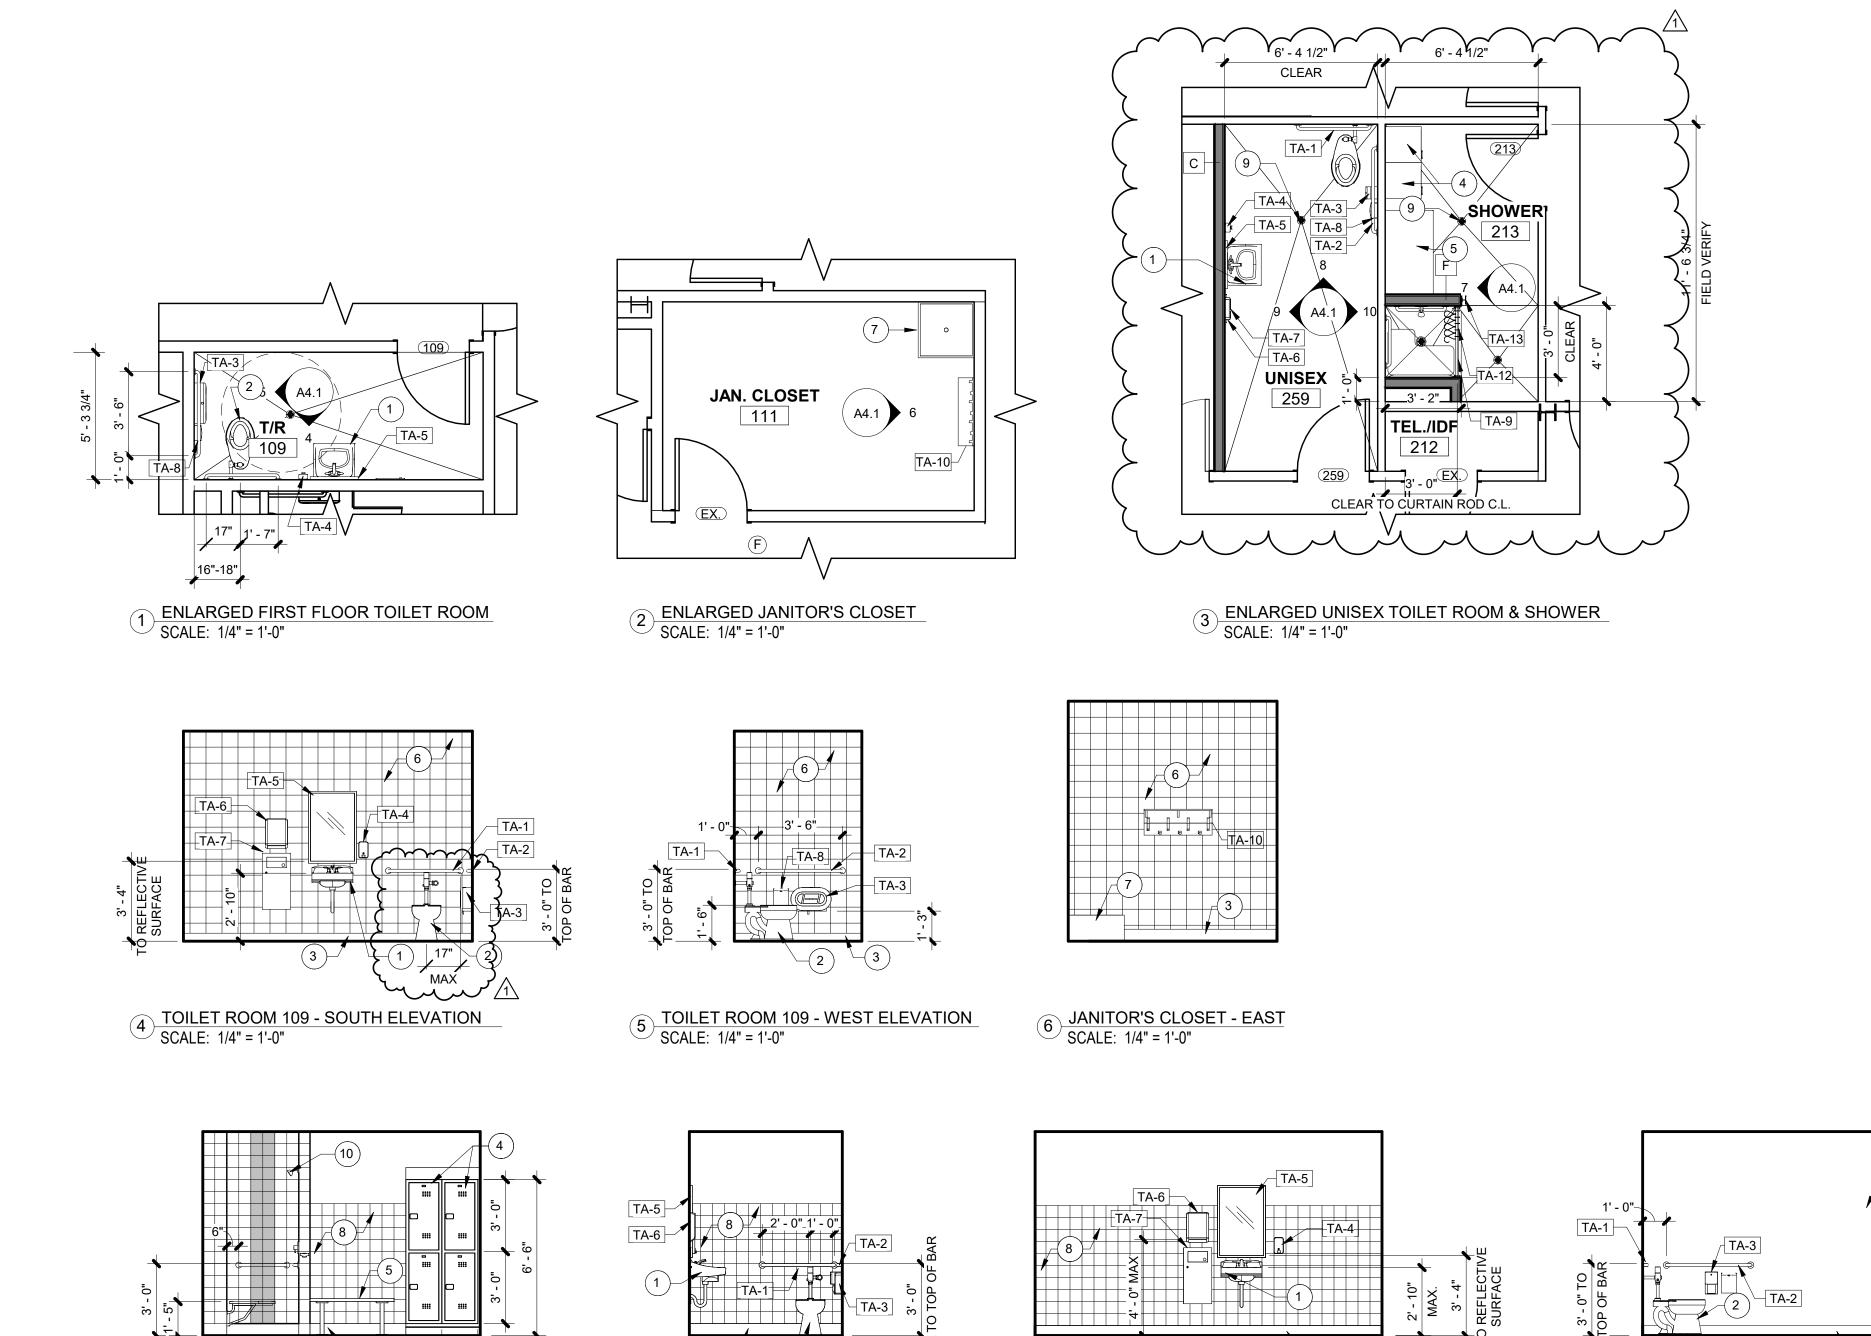

9 UNISEX 259 - WEST SCALE: 1/4" = 1'-0"

10 UNISEX 259 - EAST SCALE: 1/4" = 1'-0"

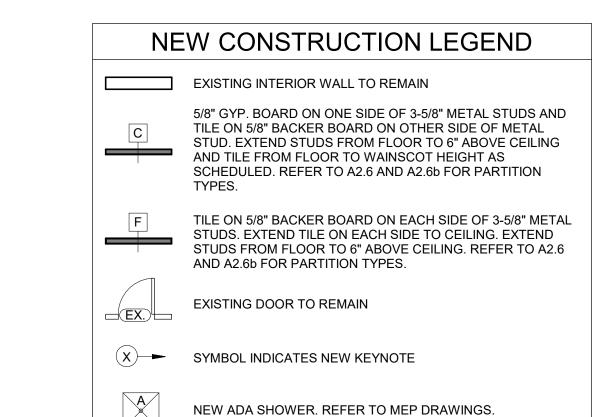

### **NEW CONSTRUCTION GENERAL NOTES**

- A. REFER TO SHEET A0.2 FOR ADDITIONAL DEMOLITION AND NEW CONSTRUCTION GENERAL NOTES.
- B. REFER TO SHEET A0.4 FOR ALL ADA DIMENSION REQUIREMENTS. C. CONFINE ALL CONSTRUCTION ACCESS / EGRESS AND DELIVERIES AS REQUIRED BY OWNER. COORDINATE TIMING OF REQUIRED CONSTRUCTION ACCESS / EGRESS WITH THE OWNER TO MINIMIZE
- INCONVENIENCE TO THE OWNER. D. REFER TO MEP DRAWINGS FOR ADDITIONAL NEW CONSTRUCTION
- REQUIREMENTS. E. GENERAL CONTRACTOR TO COORDINATE HIS SCOPE OF WORK WITH OWNER'S WORK AND SUB-CONTRACTORS THAT SHALL INCLUDE BUT
- NOT LIMITED TO DEMOLITION OF MILLWORK, PAINTING AND NEW F. GENERAL CONTRACTOR TO FIELD VERIFY ALL DIMENSIONS PRIOR TO
- ORDERING AND INSTALLING MATERIALS/ PRODUCTS. G. PROVIDE FIRE RATED BLOCKING AS NECESSARY FOR ALL WALL
- MOUNTED CASEWORK, FIXTURES, AND EQUIPMENT. REFER TO EQUIPMENT PLAN. H. EXISTING FIRE EXTINGUISHERS TO BE LOWERED TO 27" FROM THE BOTTOM OF FIRE EXTINGUISHER TO FINISH FLOOR.
- I. PROVIDE NEW ELEVATOR CONTROL PANEL FOR EXISTING THYSSENKRUPP HYDRAULIC ELEVATOR., OEM SERIAL NUMBER E-90014; 2 STOP (2 FRONT/0 REAR); SPEED: 135 FPM: CAPACITY: 250 LBS. INCLUDING THE FOLLOWING, A 32 BIT CONTROLLER WITH COMPLETELY NEW BOARDS THAT ARE FULLY SUPPORTED BY THYSSENKRUPP AND ARE
- NON PROPRIETARY. THE NEW CONTROLLER SHALL INCLUDE ALL THE CURRENT CODE PROVISIONS AS WELL AS REMOTE MONITORING SO IT CAN TELL WHEN THE ELEVATOR IS GOING TO MALFUNCTION BEFORE IT ACTUALLY DOES. IT ALSO INCLUDES BATTERY LOWERING WHICH IS A SAFETY FEATURE IN CASE THE POWER IN THE BUILDING GOES OUT.
- CONTROLLER TAC 32 CONTROLLER (INCLUDES OPTIONS LISTED BELOW)
- 1. 24 VDC SIGNAL VOLTAGE AUTO LIGHT AND FAN FEATÚRE 2. CAR INDEPENDENT SERVICE 3. CAR TRAVELING LANTERN CIRCUITRY
- 4. DOOR BYPASS OPERATION 5. ELECTRONIC DOOR DETECTOR INTERFACE
- 6. HOISTWAY ACCESS AND ENABLE THY BOARD
- eMAX MONITORING DEVICE PROVISIONS BATTERY LOWERING IN CONTROLLER
- SOLID STATE STARTERS (6 OR 12 LEADS) 460 / 575 VAC MACHINE ROOM WIRING
- J. CONTRACTOR SHALL MAKE ADJUSTMENTS AS REQUIRED IN HARD CEILINGS (GYPSUM BOARD / STUCCO) FOR NEW LIGHT FIXTURES. K. PATCH AND REPAIR ALL SURFACÉS AFTER REMOVAL OF EXISTING EMERGENCY LIGHTING.

## **ENLARGED FLOOR PLANS GENERAL NOTES**

- A. PROVIDE BLOCKING FOR ALL MOUNTED ITEMS AS PER MANUFACTURER'S RECOMMENDATIONS. TYPICAL.
- B. COORDINATE ALL OUTLET LOCATIONS WITH OWNER AND MEP
- DRAWINGS. TYPICAL. C. GENERAL CONTRACTOR TO REFER TO A11 SERIES SHEETS FOR ALL FINISHES INCLUDING CERAMIC TILE PATTERNS. TYPICAL.

  D. COORDINATE LOCATIONS OF ALL WALL MOUNTED ITEMS INCLUDING BUT NOT LIMITED TO, TOILET ACCESSORIES, PLUMBING ACCESS PANELS, ETC. IN FIELD. TYPICAL. E. REFER TO MANUFACTURER RECOMMENDATION FOR PROTECTION OF
- GROUT TO AVOID EMBEDDED DUST AND DEBRIS ACCUMULATION.

F. REFER TO MEP DRAWINGS FOR PRE-FABRICATED SHOWER.

# **NEW CONSTRUCTION KEYNOTES (X)**

- NEW LAVATORY TO BE INSTALLED. REFER TO MEP
- NEW WATER CLOSET. REFER TO MEP DRAWINGS.
- NEW BASE AS SCHEDULED. REFER TO A11.1 FOR SELECTION. NEW LOCKERS TO BE FURNISHED AND INSTALLED BY
- GENERAL CONTRACTOR. NEW ADA COMPLIANT BENCH TO BE FURNISHED AND INSTALLED BY GENERAL CONTRACTOR. BENCH SHALL BE 42"
- MINIMUM IN LENGTH AND SHALL BE AFFIXED TO WALL IF BACK SUPPORT IS NOT PROVIDED. REFER TO EQUIPMENT PLAN LEGEND A10.1.
- EXISTING CMU WALL TO BE PAINTED WITH NEW EPOXY PAINT. REFER TO A11.1 FOR PAINT COLOR SELECTION.
- NEW FLOOR SINK TO BE INSTALLED. REFER TO MEP

DRAWINGS FOR DETAILS. TYPICAL.

- NEW PORCELAIN WALL TILE AS SCHEDULED. REFER TO A11.1 FOR SELECTION. TYPICAL.
- NEW FLOOR DRAIN. REFER TO MEP DRAWINGS.

NEW SHOWER HEAD AND CONTROLS. REFER TO MEP

# **EXHIBIT N**

**ENLARGED RESTROOMS** PLAN

OF CHESNEY MORALES PARTNERS, INC.

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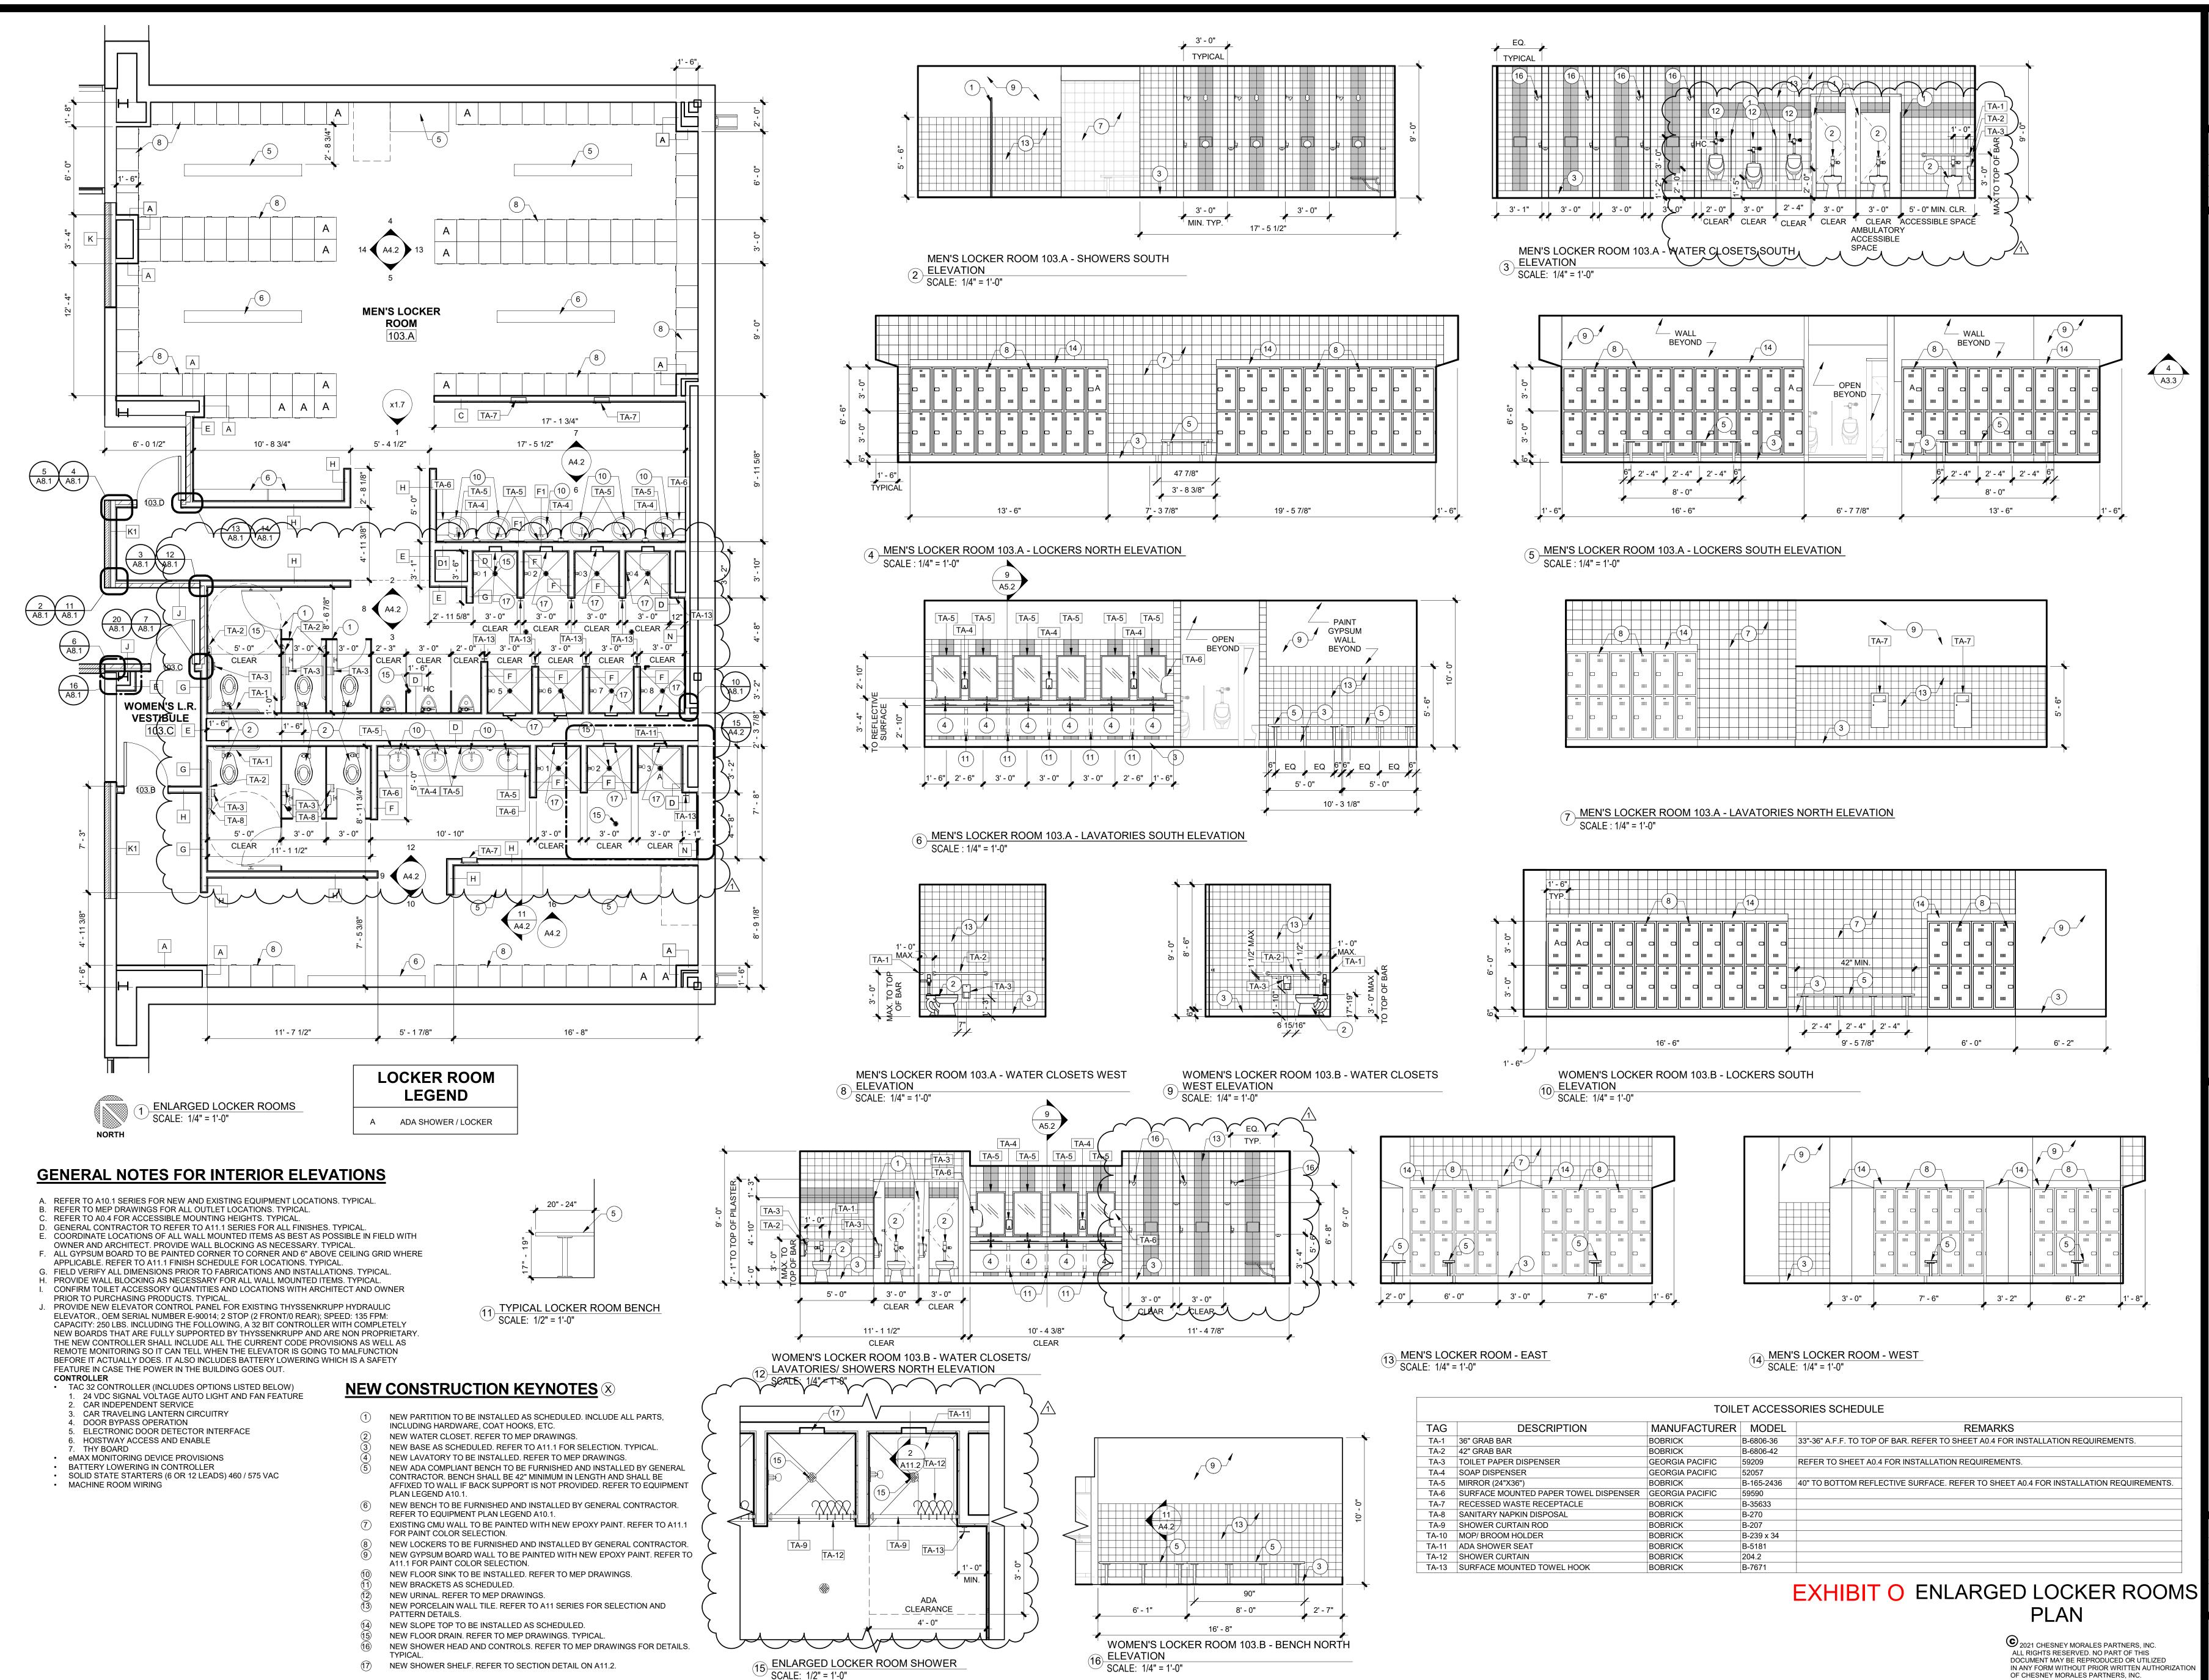
**Revision Schedule** Description Date ADD #01 5/3/2021








JOB NO: 02/05/2021 DATE: DRAWN BY: CHECKED BY:



Description Date ADD #01 5/3/2021

JOB NO: 02/05/2021

DRAWN BY: CHECKED BY:

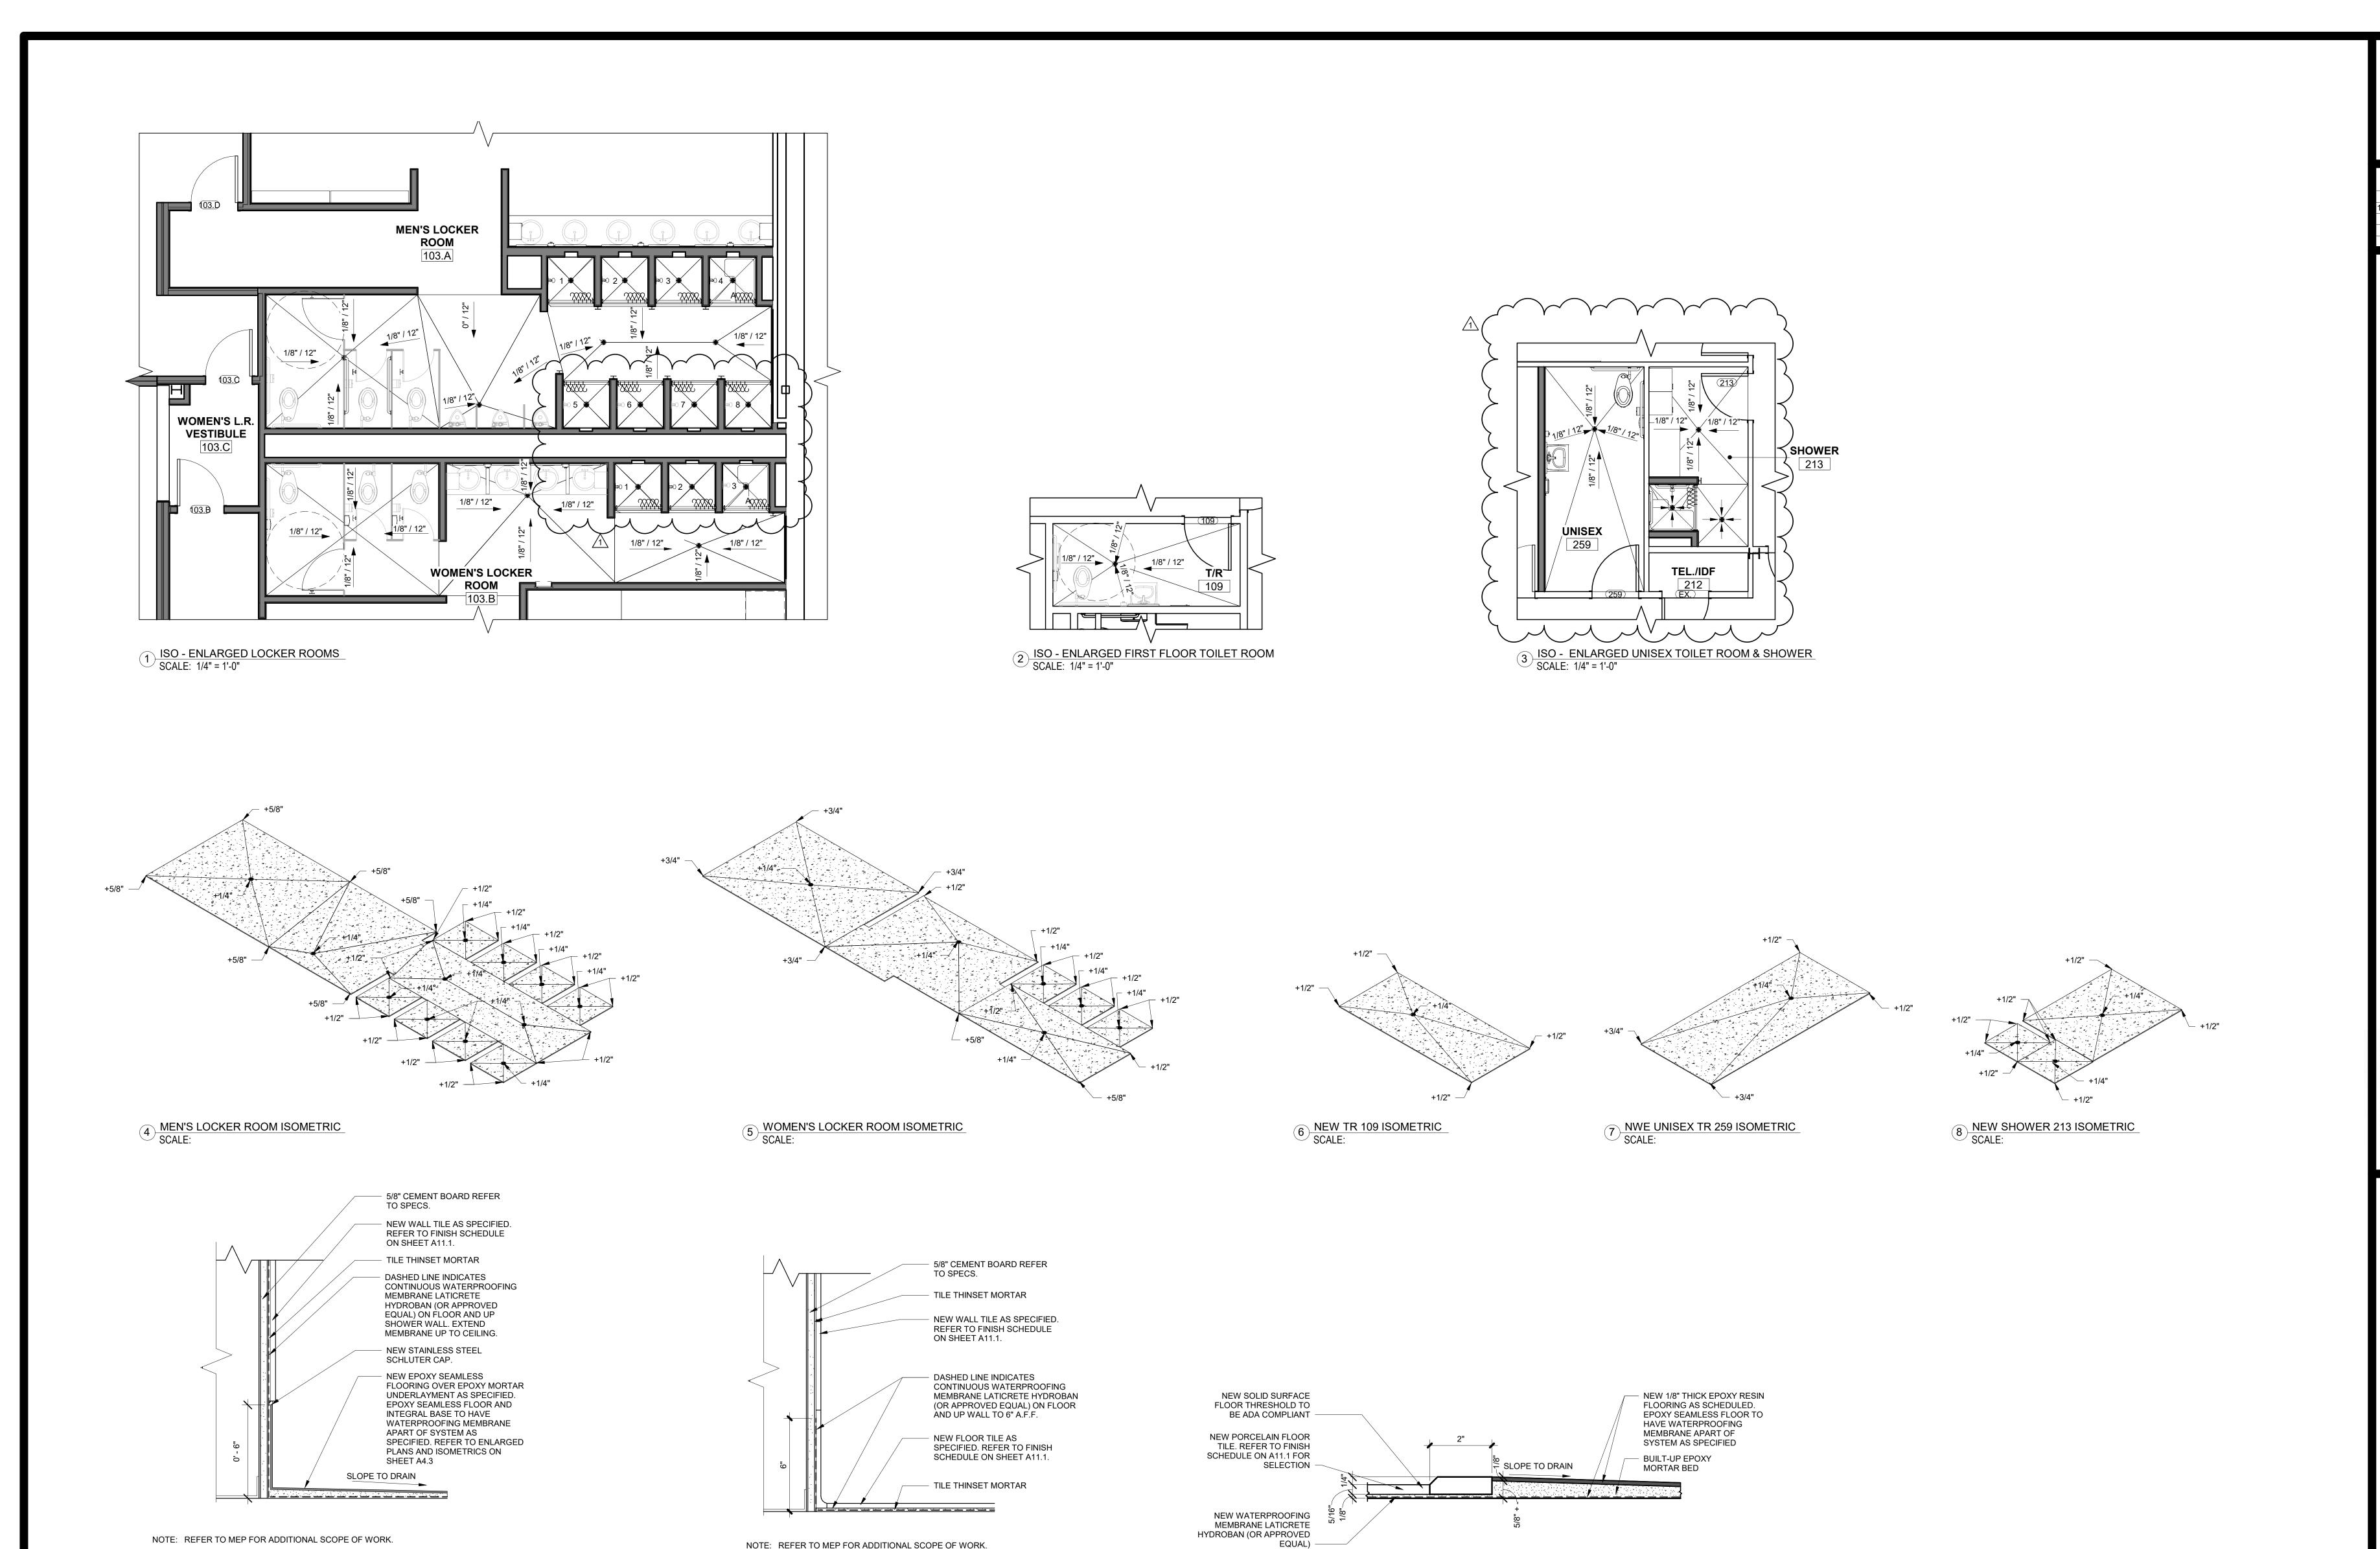

11 TYPICAL EPOXY FLOOR THRESHOLD DETAIL SCALE: 6" = 1'-0"

NOTE: REFER TO MEP FOR ADDITIONAL SCOPE OF WORK.

10 TYPICAL SECTION DETAIL - TILE FLOOR SCALE: 3" = 1'-0"

9 TYPICAL SECTION DETAIL - EPOXY FLOOR SCALE: 3" = 1'-0"

# EXHIBIT P

**EPOXY FLOOR ISOMETRIC VIEWS** 

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No. Description Date ADD #01 5/3/2021



- A. REFER TO A10.1 SERIES FOR NEW AND EXISTING EQUIPMENT LOCATIONS. TYPICAL.
  B. REFER TO MEP DRAWINGS FOR ALL OUTLET LOCATIONS. TYPICAL.
- REFER TO A0.4 FOR ACCESSIBLE MOUNTING HEIGHTS. TYPICAL.
- D. GENERAL CONTRACTOR TO REFER TO A11.1 SERIES FOR ALL FINISHES. TYPICAL. E. COORDINATE LOCATIONS OF ALL WALL MOUNTED ITEMS AS BEST AS POSSIBLE IN FIELD WITH
- OWNER AND ARCHITECT. PROVIDE WALL BLOCKING AS NECESSARY. TYPICAL. F. ALL GYPSUM BOARD TO BE PAINTED CORNER TO CORNER AND 6" ABOVE CEILING GRID WHERE APPLICABLE. REFER TO A11.1 FINISH SCHEDULE FOR LOCATIONS. TYPICAL.
- G. FIELD VERIFY ALL DIMENSIONS PRIOR TO FABRICATIONS AND INSTALLATIONS. TYPICAL. H. PROVIDE WALL BLOCKING AS NECESSARY FOR ALL WALL MOUNTED ITEMS. TYPICAL. I. CONFIRM TOILET ACCESSORY QUANTITIES AND LOCATIONS WITH ARCHITECT AND OWNER

**Revision Schedule** 

ADD #02 5/14/2021

No. Description Date

- J. PROVIDE NEW ELEVATOR CONTROL PANEL FOR EXISTING THYSSENKRUPP HYDRAULIC ELEVATOR., OEM SERIAL NUMBER E-90014; 2 STOP (2 FRONT/0 REAR); SPEED: 135 FPM: CAPACITY: 250 LBS. INCLUDING THE FOLLOWING, A 32 BIT CONTROLLER WITH COMPLETELY NEW BOARDS THAT ARE FULLY SUPPORTED BY THYSSENKRUPP AND ARE NON PROPRIETARY. THE NEW CONTROLLER SHALL INCLUDE ALL THE CURRENT CODE PROVISIONS AS WELL AS REMOTE MONITORING SO IT CAN TELL WHEN THE ELEVATOR IS GOING TO MALFUNCTION BEFORE IT ACTUALLY DOES. IT ALSO INCLUDES BATTERY LOWERING WHICH IS A SAFETY FEATURE IN CASE THE POWER IN THE BUILDING GOES OUT.
  - TAC 32 CONTROLLER (INCLUDES OPTIONS LISTED BELOW)
  - . CAR INDEPENDENT SERVICE
  - 5. ELECTRONIC DOOR DETECTOR INTERFACE
  - 6. HOISTWAY ACCESS AND ENABLE

  - 1. 24 VDC SIGNAL VOLTAGE AUTO LIGHT AND FAN FEATURE
- eMAX MONITORING DEVICE PROVISIONS
- BATTERY LOWERING IN CONTROLLER SOLID STATE STARTERS (6 OR 12 LEADS) 460 / 575 VAC

- (1) EXISTING FLOORING TO REMAIN. PROTECT FROM NEW
- CONSTRUCTION.
- NEW BALLISTIC WINDOW TO BE INSTALLED. REFER TO WINDOW SCHEDULE.
- NEW COUNTERTOP AND BACKSPLASH TO BE INSTALLED AS SCHEDULED.
- EXISTING CMU WALL TO BE PAINTED WITH NEW EPOXY PAINT. REFER TO A11.1 FOR PAINT COLOR SELECTION.
- NEW STEEL UNDERCOUNTER SUPPORT BRACKET. SUPPORT BRACKET TO BE PAINTED TO MATCH EXISTING ADJACENT WALL FINISH. INSTALL SUPPORT BRACKETS 32" ON CENTER.
- NEW WALL-MOUNTED CASEWORK WITH OPEN, ADJUSTABLE SHELVING. REFER TO FINISH SCHEDULE.
- NEW WOOD MAILBOX. REFER TO FINISH SCHEDULE. NEW UPPER CABINET. REFER TO FINISH SCHEDULE.
- NEW BASE CABINET. REFER TO FINISH SCHEDULE. NEW GYPSUM BOARD WALL TO BE PAINTED. REFER TO FINISH
- NEW BULLETIN BOARD AS SPECIFIED.
- NEW COUNTERTOP, UPPER AND LOWER CABINETS TO BE INSTALLED. REFER TO A11.1 FOR FINISH SELECTIONS.
- NEW ELEVATOR INTERIOR PANELS AS SCHEDULED.
- NEW ELEVATOR HANDRAIL AS SCHEDULED. NEW BASE AS SCHEDULED. REFER TO FINISH SCHEDULE.
- EXISTING ELEVATOR CAB. PROVIDE NEW ELEVATOR CONTROL PANEL FOR EXISTING
- THYSSENKRUPP HYDRAULIC ELEVATOR. REFER TO GENERAL NOTES FOR DESCRIPTION OF COMPONENTS.
- EXISTING ELEVATOR SHAFT CMU WALLS.
- NEW FLOORING AS SCHEDULED. NEW LEVEL 1 BALLISTIC GLAZING AS SPECIFIED.
- NEW LEVEL 1 BALLISTIC RECESSED TRANSACTION TRAY AS
- NEW LEVEL 1 BALLISTIC STAINLESS STEEL WINDOW FRAME AS
- SPECIFIED.

  (23) NEW METAL STUD WALL WITH 1/8" ARMOR PLATE. REFER TO)

  10/A5.2 FOR PARTITION TYPES.

  24) EXISTING DOOR TO REMAIN.
  - NEW RECESSED BODY CAMERA CHARGING STATION. NEW 3-5/8" METAL STUD AT 16" O.C.
  - NEW 1x3 WOOD TRIM.
  - CONTRACTOR TO MATCH LOCATION OF EXISTING REVEALS.
  - NEW LEVEL 1 BALLISTIC COUNTERTOP WITH SOLID SURFACE TOP TO BE INSTALLED AS SCHEDULED.
  - BATTEN TO STOP HERE. NEW SOLID SURFACE COUNTERTOP WITH HEAVY DUTY HINGE.
  - 32) NEW COUNTERTOP AS SCHEDULED. REFER TO A11.1 FOR

EXHIBIT Q

INTERIOR ELEVATIONS

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SHEET A5.

05/03/2021

JOB NO:

DATE:

DRAWN BY:

CHECKED BY:



134	VESTIBULE	EXISTING	EXISTING	EXISTING	EXISTIN	IG	EXISTING		EXISTING		PTD.	GYP.	10' - 0"
S2	STAIRS	EXISTING	EXISTING	PT-1	PT-1		PT-1		PT-1		PTD.	GYP.	EXISTING
						·		·					
				SECOND E	LOOR ROOM FIN	ISH SCHEDI	II E RASE RID	<u> </u>					
				SECONDT				,	1				
ROOM NUMBER	ROOM NAME		FLOOR	BASE	N1		LLS	107	MILLWORK	CEILING	CEILING HEIGHT	REMARKS	SIGNAGE
	CENTRAL CORRIDOR		CPT-1	D 1	N FOKNI #7	E	S FOUN #7	W FOKN #7		DTD CVD			TYPE QTY
200	CENTRAL CORRIDOR CENTRAL CORRIDOR		CPT-1	B-1 B-1	FSKN #7 PT-1	PT-1	FSKN #7 PT-1	FSKN #7 PT-1		PTD. GYP. ACT-1	9' - 0"/ 10' - 0"		
200A 200B	CENTRAL CORRIDOR		CPT-1	B-1	PT-1	PT-1	PT-1	PT-1		ACT-1	10 - 0"		
200D	CENTRAL CORRIDOR		CPT-1	B-1	PT-1/ FSKN #7	PT-1	PT-1	PT-1		ACT-1/ PTD. GYP.	10' - 0"		
200D	CORRIDOR		EXISTING	EXISTING	EXISTING	EXISTING	EXISTING	EXISTING		ACT-1	8' - 6"		A 1
200E	CORRIDOR		EXISTING	EXISTING	EXISTING	EXISTING	EXISTING	EXISTING		ACT-1	8' - 6"		A 2
200F	CORRIDOR		EXISTING	EXISTING	EXISTING	EXISTING	EXISTING	EXISTING		ACT-1	8' - 6"		A 2
200G	CORRIDOR		EXISTING	EXISTING	EXISTING	EXISTING	EXISTING	EXISTING		ACT-1	8' - 6"		A 1
201	HR OFFICE / WAITING		EXISTING	EXISTING	EXISTING	EXISTING	EXISTING	EXISTING		ACT-1	8' - 6"		A 1
201.A	ADMIN. ASSISTANT		EXISTING	EXISTING	EXISTING	EXISTING	EXISTING	EXISTING		ACT-1	8' - 6"		A 2
202	ADMIN. SRGNT'S OFFICE		EXISTING	EXISTING	EXISTING	EXISTING	EXISTING	EXISTING		ACT-1	8' - 6"		C 1
203	LIEUT. OFFICE (DISTRICTS)		EXISTING	EXISTING	EXISTING	EXISTING	EXISTING	EXISTING		ACT-1	8' - 6"		C 1
204	APPLICANT PROCESSING ROOM		EXISTING	EXISTING	EXISTING	EXISTING	EXISTING	EXISTING		ACT-1	8' - 6"		A 1
205	APPLICANT PROCESSING STORAGE		EXISTING	EXISTING	EXISTING	EXISTING	EXISTING	EXISTING		ACT-1	8' - 6"		A 1
206	WORK ROOM		EXISTING	EXISTING	EXISTING	EXISTING	EXISTING	EXISTING		ACT-1	8' - 6"		A 1
207	ADMIN. SRGNT'S OFFICE (FUTURE)		EXISTING	EXISTING	EXISTING	EXISTING	EXISTING	EXISTING		ACT-1	8' - 6"		C 1
208	CORRIDOR		CPT-1	B-1	PT-1	PT-1	PT-1	PT-1		ACT-1	8' - 6"		A 2
209	LIEUT. OFFICE (RIVER)		EXISTING	EXISTING	EXISTING	EXISTING	EXISTING	EXISTING		ACT-1	8' - 6"		C 1
210	CAPTAIN'S OFFICE		CPT-1	B-1	PT-1	PT-1	PT-1	PT-1		ACT-1	8' - 6"		C 1
211 212	ADMIN. ASST. / ADMIN. FILES TEL./IDF		EXISTING EXISTING	EXISTING EXISTING	EXISTING	EXISTING EXISTING	EXISTING EXISTING	EXISTING EXISTING		ACT-1 PTD. GYP.	8' - 6" 10' - 0"		C 1
212	SHOWER		EZISTING EP-1	B-2	EXISTING PT-1	PT-1	FSKN #2, #4	FSKN3, #4		PTD. GYP.	8' - 6"		A 1 A 1
214	CONFERENCE ROOM		EXISTING	EXISTING	EXISTING	EXISTING	EXISTING	EXISTING		ACT-1	8' - 6"		C 1
215	QUIET/ LACTATION ROOM		LVT-1	B-1	PT-1	PT-1	PT-1	PT-1		ACT-1	8' - 6"		A 1
216	BREAK ROOM		EXISTING	EXISTING	EXISTING	EXISTING	EXISTING	EXISTING		ACT-1	8' - 6"		A 1
217	MECH.		EXISTING	EXISTING	EXISTING	EXISTING	EXISTING	EXISTING		EXISTING	OPEN		A 1
219	STOR.		EXISTING	EXISTING	EXISTING	EXISTING	EXISTING	EXISTING		PTD. GYP.	9' - 0"		A 1
220	MEN		EXISTING	EXISTING	EXISTING	EXISTING	EXISTING	EXISTING		PTD. GYP.	9' - 0"		B 1
221	JAN.		EXISTING	EXISTING	EXISTING	EXISTING	EXISTING	EXISTING		PTD. GYP.	OPEN		A 1
222	WOMEN		EXISTING	EXISTING	EXISTING	EXISTING	EXISTING	EXISTING		PTD. GYP.	9' - 0"		B 1
223	ELEC./IDF		EXISTING	EXISTING	EXISTING	EXISTING	EXISTING	EXISTING		PTD. GYP.	9' - 0"		A 1
225	CORE SQUADROOM FILE AREA/ CORE SU	PERVISOR'S C		EXISTING	EXISTING	EXISTING	EXISTING	EXISTING		ACT-1	8' - 6"		C 1
226	CORE SQUAD ROOM 1		EXISTING	EXISTING	EXISTING	EXISTING	EXISTING	EXISTING		ACT-1	8' - 6"		C 1
227	CORE SQUAD ROOM 4		EXISTING	EXISTING	EXISTING	EXISTING	EXISTING	EXISTING		ACT-1	8' - 6"		C 1
228	OFF DUTY EMPLOYMENT OFFICE		EXISTING	EXISTING	EXISTING	EXISTING	EXISTING	EXISTING		ACT-1	8' - 6"		C 1
229	UNDER COVER STORAGE		EXISTING	EXISTING	EXISTING	EXISTING	EXISTING	EXISTING		ACT-1	8' - 6"		A 1
230	UNDER COVER OFFICE UNDER COVER OFFICE		EXISTING EXISTING	EXISTING EXISTING	EXISTING EXISTING	EXISTING EXISTING	EXISTING EXISTING	EXISTING EXISTING		ACT-1 ACT-1	8' - 6" 8' - 6"		C 1
232	RESEARCH & PLANNING OFFICE		EXISTING	EXISTING	EXISTING	EXISTING	EXISTING	EXISTING		ACT-1	8' - 6"		C 1
233	CORE SQUAD ROOM 2 & 3		EXISTING	EXISTING	EXISTING	EXISTING	EXISTING	EXISTING		ACT-1	8' - 6"		C 1
234	FLEET OFFICE		EXISTING	EXISTING	EXISTING	EXISTING	EXISTING	EXISTING		ACT-1	8' - 6"		C 1
235	SRGNT'S WRKSTN (RIVER) 6		EXISTING	EXISTING	EXISTING	EXISTING	EXISTING	EXISTING		ACT-1	8' - 6"		C 1
237	SRGNT'S WRKSTN (RIVER)1		EXISTING	EXISTING	EXISTING	EXISTING	EXISTING	EXISTING		ACT-1	8' - 6"		C 1
238	SRGNT'S WRKSTN (RIVER) 5		EXISTING	EXISTING	EXISTING	EXISTING	EXISTING	EXISTING		ACT-1	8' - 6"		C 1
239	SRGNT'S WRKSTN (RIVER) 4		EXISTING	EXISTING	EXISTING	EXISTING	EXISTING	EXISTING		ACT-1	8' - 6"		C 1
240	SRGNT'S WRKSTN (RIVER) 3		EXISTING	EXISTING	EXISTING	EXISTING	EXISTING	EXISTING		ACT-1	8' - 6"		C 1
241	SRGNT'S WRKSTN (RIVER) 2		EXISTING	EXISTING	EXISTING	EXISTING	EXISTING	EXISTING		ACT-1	8' - 6"		C 1
242	SRGNT'S WRKSTN (DISTRICTS) 6		EXISTING	EXISTING	EXISTING	EXISTING	EXISTING	EXISTING		ACT-1	8' - 6"		C 1
243	SQUADROOM FILE AREA (DISTRICTS)		EXISTING	EXISTING	EXISTING	EXISTING	EXISTING	EXISTING		ACT-1	8' - 6"		A 1
245	WORK ROOM / SRGNT WRKSTN (DISTRICT	S) 5	EXISTING	EXISTING	EXISTING	EXISTING	EXISTING	EXISTING		ACT-1	8' - 6"		C 1
246	SRGNT'S WRKSTN (DISTRICTS) 4		EXISTING	EXISTING	EXISTING	EXISTING	EXISTING	EXISTING		ACT-1	8' - 6"		C 1
247	SRGNT'S WRKSTN (DISTRICTS) 3		EXISTING	EXISTING	EXISTING	EXISTING	EXISTING	EXISTING		ACT-1	8' - 6"		C 1
248	SRGNT'S WRKSTN (DISTRICTS) 2		EXISTING	EXISTING	EXISTING	EXISTING	EXISTING	EXISTING		ACT-1	8' - 6" 8' - 6"		C 1
249 250	SRGNT'S WRKSTN (DISTRICTS) 1 INTERNAL AFFAIRS INTERVIEW DEVICE R	$\Omega \cap M$	EXISTING EXISTING	EXISTING EXISTING	EXISTING EXISTING	EXISTING EXISTING	EXISTING EXISTING	EXISTING EXISTING		ACT-1 ACT-1	8' - 6"		C 1 A 1
250	INTERNAL AFFAIRS INTERVIEW ROOM / DI			EXISTING	EXISTING	EXISTING	EXISTING	EXISTING		ACT-1	8' - 6"		C 1
252	INTERNAL AFFAIRS SRGNT'S OFFICE		EXISTING	EXISTING	EXISTING	EXISTING	EXISTING	EXISTING		ACT-1	8' - 6"		C 1
253	ADMINISTRATIVE WORKSPACE		EXISTING	EXISTING	EXISTING	EXISTING	EXISTING	EXISTING		ACT-1	8' - 6"		C 1
254	LIEUTENANT'S OFFICE (FUTURE)		EXISTING	EXISTING	EXISTING	EXISTING	EXISTING	EXISTING		ACT-1	8' - 6"		C 1
255	STORAGE		EXISTING	EXISTING	EXISTING	EXISTING	EXISTING	EXISTING		ACT-1	8' - 6"		A 1
256	SQUADROOM FILE AREA (RIVER)		EXISTING	EXISTING	EXISTING	EXISTING	EXISTING	EXISTING		ACT-1	8' - 6"		A 1
257	READY ROOM		EXISTING	EXISTING	EXISTING	EXISTING	EXISTING	EXISTING		ACT-1	8' - 6"		A 1
259	UNISEX		EP-1	B-2	FSKN #2	PT-1	PT-1	FSKN #2		ACT-2	8' - 6"		E 1

259	UNISEX	EP-I D-Z	F3NN #2	PI-I PI-I	F3NN #2	AC1-2	0 - 0	
ALL CERAMIC	T-1. WALL TILE CWT-2 AT WATER CLOSET/URINAL AREAS. TYPICAL.	NEW 1' - 0" WIDE ACCENT BAND (CWT-2) TO BE CENTERED AT EVERY MIRROR AND SHOWER FIXTURE. FIELD VERIFY ALL DIMENSIONS. TYPICAL.  RNER GUARD CG-1 AT ALL OUTSIDE	1'-0" TYPICAL 1 -8-21/4		ALL CERAMIC WALL TILE TO COBEHIND CASEWORK, FIXTURES EQUIPMENT. TYPICAL.  NEW BPI SCHLUTER QUADEC (CAPPROVED EQUAL) ANODIZED ALUMINUM WALL TRIM. TYPICAL NEW TILE CORNER GUARD (CG-1) AT ALL OUTSIDE CORNERS. CORNER GUARD TO GO HEIGHT OF TILE WAINSCOTTYPICAL.  NEW 6" X 6" CERAMIC WALL TILE (CWT-1). TYPICAL.  NEW BASE AS SCHEDULED TYPICAL.	, AND DR	NEW EPOXY FIELD PAINT PT-1. TYPICAL.	5'-6"

TYPICAL ACCENT WALL TILE PATTERN ELEVATION TYPICAL WALL TILE PATTERN ELEVATION  $^{\prime}$  SCALE: 1/4" = 1'-0" REFERENCE TO FSKN #4. TYPICAL. REFERENCE TO FSKN #3. TYPICAL.

SCALE: 1/4" = 1'-0"

TYPICAL WAINSCOT WALL TILE PATTERN ELEVATION SCALE: 1/4" = 1'-0" REFERENCE TO FSKN #2. TYPICAL.

### FINISH SCHEDULE KEY NOTES (FSKN):

- TYPICAL FIELD PAINT TO BE PT-1. NEW FIELD PAINT TO BE APPLIED CORNER TO CORNER OF WALL IN ITS ENTIRETY AND 6" ABOVE CEILING. NEW ACCENT PAINT TO BE PT-2 4. FINAL ACCENT PAINT LOCATIONS TO BE CONFIRMED BY OWNER AND ARCHITECT. REFER JOINTLY WITH ROOM FINISH SCHEDULE ON SHEET A11.1, NEW CONSTRUCTION FLOOR PATTERN PLAN - SECOND FLOOR 1/A11.3, AND PARTIAL NEW CONSTRUCTION FINISH PLAN 1 /A11.4 FOR LOCATIONS. GENERAL CONTRACTOR TO PROVIDE 24" X 24" ON-SITE MOCKUPS OF ALL PAINT COLORS FOR ARCHITECT AND OWNER REVIEW PRIOR TO ORDERING MATERIALS. PREPARE NEW AND/OR EXISTING WALLS AS SPECIFIED TO RECEIVE NEW CERAMIC WALL TILE (CWT-1) FROM 6" A.F.F. TO 5' - 6" A.F.F. PROVIDE NEW BPI SCHLUTER QUADEC (OR APPROVED EQUAL) ANODIZED
- ALUMINUM WALL TRIM AT TOP OF WALL TILE WAINSCOT. PROVIDE NEW TILE CORNER GUARD (CG-1) AT ALL OUTSIDE CORNERS. INSTALL ALL MATERIALS PER MANUFACTURER'S RECOMMENDATIONS. ENSURE ALL GROUT JOINTS ARE ALIGNED AND ALL TILE IS FLUSH TO EACH OTHER. REFER JOINTLY WITH ROOM FINISH SCHEDULE ON SHEET A11.1 AND PARTIAL NEW CONSTRUCTION FINISH FLOOR PLAN(S) 3 AND 5/A11.4 FOR LOCATIONS. REFER TO TYPICAL WAINSCOT WALL TILE PATTERN ELEVATION 3/A11.1 FOR DETAILS.
- PREPARE NEW AND/OR EXISTING WALLS AS SPECIFIED TO RECEIVE NEW CERAMIC WALL TILE (CWT-1) AND NEW CERAMIC WALL ACCENT TILE (CWT-2) FROM 6" A.F.F. TO BOTTOM OF CEILING (FULL HEIGHT OF WALL). PROVIDE NEW TILE CORNER GUARD CG-1 AT ALL OUTSIDE CORNERS. INSTALL ALL MATERIALS PER MANUFACTURER'S RECOMMENDATIONS. ENSURE ALL GROUT JOINTS ARE ALIGNED AND ALL TILE IS FLUSH TO EACHOTHER. REFER JOINTLY WITH ROOM FINISH SCHEDULE ON SHEET A11.1 AND PARTIAL NEW CONSTRUCTION FINISH FLOOR PLAN(S) 3 AND 5/A11.4 FOR LOCATIONS. REFER TO TYPICAL ACCENT WALL TILE PATTERN ELEVATION 1/A11.1 FOR DETAILS.
- PREPARE NEW AND/OR EXISTING WALLS AS SPECIFIED TO RECEIVE NEW CERAMIC WALL TILE (CWT-1) FROM 6" A.F.F. TO BOTTOM OF CEILING (FULL HEIGHT OF WALL). PROVIDE NEW TILE CORNER GUARD CG-1 AT ALL OUTSIDE CORNERS. INSTALL ALL MATERIALS PER MANUFACTURER'S RECOMMENDATIONS. ENSURE ALL GROUT JOINTS ARE ALIGNED AND ALL TILE IS FLUSH TO EACHOTHER.REFER JOINTLY WITH ROOM FINISH SCHEDULE ON SHEET A11.1 AND PARTIAL NEW CONSTRUCTION FINISH PLAN(S) 1 AND 2/A11.4 FOR LOCATIONS. REFER TO TYPICAL WALL TILE PATTERN 2/A11.1 FOR DETAILS. 5. AT AUDITORIUM/ ROLL CALL ROOM 105, PREPARE EXISTING SUBFLOOR AS NECESSARY TO RECEIVE NEW CARPET FLOOR TILE (CPT-1 AND CPT-2). INSTALL ALL MATERIALS PER MANUFACTURER'S RECOMMENDATIONS.
- REFER TO NEW CONSTRUCTION FLOOR PATTERN PLAN FIRST FLOOR 1/A11 2 FOR LOCATIONS AND DETAILS. AT LOBBY 110.A, PREPARE EXISTING CMU AND EXISTING STUCCO INTERIOR WALLS TO RECEIVE NEW FIELD PAINT (PT-1) FROM 4" A.F.F. TO 16'-6-1/4" A.F.F. NEW ACCENT PAINT (PT-2 AND PT-3) TO BE INSTALLED FROM 16'-6-1/4" A.F.F TO BOTTOM OF CEILING (FULL HEIGHT OF WALL). INSTALL ALL MATERIALS PER MANUFACTURER'S RECOMMENDATIONS. REFER JOINTLY WITH ROOM FINISH SCHEDULE ON SHEET A11.1, NEW

CONSTRUCTION FLOOR PATTERN PLAN - SECOND FLOOR 1/A11.3, AND PARTIAL NEW CONSTRUCTION FINISH PLAN 1 /A11.4 FOR LOCATIONS. REFER TO TYPICAL LOBBY WALL PAINT PATTERN ELEVATION 2/A11.4 AND

EXISTING LOBBY REFERENCE IMAGE 6/A11.4 FOR DETAILS. GENERAL CONTRACTOR TO PROVIDE ON - SITE MOCK UP FOR REVIEW OF PATTERN FOR ARCHITECT AND OWNER TO REVIEW PRIOR TO INSTALLATION. AT SECOND FLOOR CENTRAL CORRIDOR 200, PREPARE EXISTING WALLS TO RECEIVE NEW FIELD PAINT (PT-1) FROM 4" A.F.F. TO 2'-6-1/4" A.F.F. NEW ACCENT PAINT (PT-2 AND PT-3) TO BE INSTALLED FROM 2'-6-1/4" A.F.F. TO BOTTOM OF CEILING (FULL HEIGHT OF WALL). INSTALL ALL MATERIALS PER MANUFACTURER'S RECOMMENDATIONS. REFER JOINTLY WITH ROOM FINISH SCHEDULE ON SHEET A11.1, NEW CONSTRUCTION FLOOR PATTERN PLAN - SECOND FLOOR 1/A11.3, AND PARTIAL NEW CONSTRUCTION FINISH PLAN 1 /A11.4 FOR LOCATIONS. REFER TO TYPICAL SECOND FLOOR CORRIDOR WALL PAINT PATTERN ELEVATION 4/A11.4 AND EXISTING LOBBY REFERENCE IMAGE 6/A11.4 FOR DETAILS. GENERAL CONTRACTOR TO PROVIDE ON - SITE MOCK UP FOR REVIEW OF PATTERN FOR ARCHITECT AND OWNER TO REVIEW PRIOR TO INSTALLATION.


#### **FINISH SCHEDULE GENERAL NOTES:**

- GENERAL CONTRACTOR SHALL REFER TO GENERAL NOTES ON SHEET A 0.2 IN ADDITION TO THE GENERAL NOTES BELOW. TYPICAL REFER TO SHEET A0.4 FOR ALL ADA REQUIREMENTS, TYPICAL..
- REFER TO REFLECTED NEW CEILING PLAN(S) FOR ALL NEW AND EXISTING CEILING DETAILS. TYPICAL.

12. ALL PORCELAIN FLOOR AND WALL TILE JOINTS TO ALIGN AND BE FLUSH TO EACH OTHER. TYPICAL.

- PROVIDE FULL SIZE SAMPLES, SHOP DRAWINGS, AND DATA SHEETS FOR ALL FINISHES SPECIFIED ON FINISH LEGEND FOR ARCHITECT AND OWNER APPROVAL PRIOR TO ORDERING MATERIAL. TYPICAL. 5. AT FLOORING TRANSITIONS, FLOAT AND FILL SUBFLOOR AS NECESSARY TO PROVIDE A FLUSH TRANSITION BETWEEN NEW AND EXISTING MATERIALS, TYPICAL,
- ALL NEW PAINT TO BE APPLIED CORNER TO CORNER OF EXISTING AND NEW GYPSUM BOARD WALL AND/OR COLUMNS IN THEIR ENTIRETY WHERE SPECIFIED. NEW PAINT TO BE APPLIED FROM FINISH FLOOR TO 6" ABOVE CEILING, TYPICAL. GENERAL CONTRACTOR TO PREPARE EXISTING FLOORING AND SUB-FLOOR AT ANY DAMAGED AREAS OF WORK WHERE THERE ARE VOIDS, REMOVED VINYL COMPOSITION TILE, REMOVED CARPET TILE, REMOVED
- FLOOR DRAINS, AND REMOVED THRESHOLDS AT AREAS OF NEW SLAB CORING, OR TRENCHING, ETC. TO MAKE ALL FLOORING SMOOTH AND LEVEL. CAP VOID WITH CONCRETE ARDEX K 15 OR APPROVED EQUAL AS REQUIRED, APPLY PER MANUFACTURER'S RECOMMENDATIONS, COORDINATE WITH NEW FLOORING MANUFACTURER'S RECOMMENDATIONS, TYPICAL, ALL NEW BASE TO BE APPLIED TO EXISTING AND/OR NEW WALLS, MILLWORK, INSIDE KNEE SPACES, ETC. COORDINATE WITH ROOM FINISH SCHEDULE FOR LOCATIONS AND TYPES. TYPICAL.
- PROVIDE NEW WALL BASE B-1 AT AREAS OF NEW MILLWORK AND/OR NEW WALLS USING A FULL RUN OF WALL BASE AVOIDING MULTIPLE SEAMS. TYPICAL. 10. ALL NEW FLOORING TO CONTINUE UNDER MILLWORK, EQUIPMENT, AND FIXTURES. TYPICAL.
- 11. GENERAL CONTRACTOR TO PATCH AND REPAIR ALL EXISTING AND NEW GYPSUM BOARD, STUCCO, OR CMU WALLS IN PROJECT AREA IF DAMAGED DURING CONSTRUCTION. FINISH LEVELS OF EXISTING GYPSUM BOARD WALLS ARE TO MATCH EXISTING ADJACENT. FINISH LEVELS OF NEW WALLS ARE TO BE LEVEL 4 MINIMUM. PREPARE TO RECEIVE NEW PAINT FINISHES AS SPECIFIED. TYPICAL.
- 13. GENERAL CONTRACTOR TO PROTECT EXISTING WALL MOUNTED AND CEILING MOUNTED EQUIPMENT/ FIXTURES TO REMAIN AT ALL TIMES DURING CONSTRUCTION. TYPICAL. 14. GENERAL CONTRACTOR TO TAKE ALL PRECAUTIONS NECESSARY TO AVOID ANY TYPE OF OVERPAINT ON SPRINKLERS AND/OR CONCEALED SPRINKLER PLATES, ALARMS, EXIT SIGNS, WIRELESS HUB DEVICES, SMOKE DETECTORS, WHITE BOARDS, PROJECTION SCREEN ETC. COORDINATE WITH OWNER AND ARCHITECT PRIOR TO START OF WORK TYPICAL. 15. GENERAL CONTRACTOR TO PREP, REPAIR, AND/OR REPLACE EXISTING FINISHES INCLUDING PAINT, CARPET, BASE, PAVERS, TILE, CEILINGS, ETC. THAT ARE DAMAGED DURING CONSTRUCTION. NEW MATERIALS ARE TO
- MATCH EXISTING ADJACENT IN SPACE AND BE INSTALLED PER MANUFACTURER'S RECOMMENDATIONS. TYPICAL. 16. GENERAL CONTRACTOR TO REFER TO A0.1 FOR ALL ADD ALTERNATE DESCRIPTIONS FOR FINISH INSTALLATION LOCATIONS. TYPICAL. 17. AT NEW FLOOR AND WALL TILE AREAS, ENSURE NEW WATERPROOFING MEMBRANE IS APPLIED TO SUBSTRATE PER MANUFACTURER'S RECOMMENDATIONS. NEW WATERPROOFING MEMBRANE TO BE LATICRETE
- HYDROBAN OR APPROVED EQUAL, TYPICAL. 18. GENERAL CONTRACTOR TO PAINT NEW AND/OR EXISTING DOOR FRAMES IN THEIR ENTIRETY WITH NEW DOOR FRAME PAINT PT-6. COORDINATE WITH DOOR SCHEDULE ON A3.2 FOR DOOR FRAME DETAILS. COVER AND
- 19. GENERAL CONTRACTOR TO PROVIDE SHOP DRAWINGS FOR REVIEW OF NEW SIGNAGE. FINAL COLORS, SIZES, QUANTITIES, VERBIAGE, ETC. TO BE CONFIRMED WITH ARCHITECT AND OWNER PRIOR TO ORDERING. ALL SIGNAGE TO BE INSTALLED PER ADA/ TDLR STANDARDS. TYPICAL.

1		FINISH LEGEND
SELECTION	PRODUCT	MANUFACTURER/ COLOR/ PATTERN/ SIZE
FLOOR		
PFT-1	PORCELAIN FLOOR TILE	DALTILE/ ASTRONOMY/ ORION AT71/ 12" X 24"/ GROUT: EPOXY GROUT/ COLOR TO BE SELECTED FROM MANUFACTURER'S FULL COLOR LINE/ 3/16" GROUT JOINT
VCT-1	VINYL COMPOSITION TILE	ARMSTRONG FLOORING/ STANDARD IMPERIAL TEXTURE/ 51908 PEWTER/ 12" X 1/8" THICK
S.C.	SEALED CONCRETE	ARDEX/ CONCRETE GUARD (CG)/ CLEAR/ WATERBONE ACRYLIC SEALER
CPT-1	CARPET TILE (2ND FLOOR)	J+J FLOORING/ FAST TRACK 7578/ 3217 NITRO/ 18" X 36"
CPT-2	CARPET TILE	J+J FLOORING/ KINETICS/ CATALYST 1841/ 2846 ACCELERATOR / 24" X 24"
CPT-3	CARPET TILE ACCENT	J+J FLOORING/ KINETICS/ CATALYST 1841/ 2845 PHASE / 24" X 24"
EP-1	EPOXY SEAMLESS FLOOR	SHERWIN WILLIAMS/ DECORATIVE MOSAIC FLEX SYSTEM/ COLOR: CU11/ WATERPROOFING SYSTEM AND SLIP RESISTANT TOP COATING PER MANUFACTURER'S RECOMMENDATION OF THE PROOF
LVT-1	LUXURY VINYL TILE	J+J FLOORING/ CLASSICS LVT/ 1008 PARDIGN/ 9" X 48"
BASE		
B-1	RUBBER COVE BASE	JOHNSONITE/ BASEWORKS THERMOSET RUBBER (TS)/ TOE/ 40 BLACK/ 4" HIGH COVE BASE X 120' COIL
B-2	INTEGRAL EPOXY COVE BASE	SHERWIN WILLIAMS/ DECORATIVE MOSAIC FLEX SYSTEM/ COLOR: CU11/ 6" HIGH INTEGRAL COVE BASE WITH STAINLESS STEEL COVE CAP
B-3	PORCELAIN TILE COVE BASE	DALTILE/ ASTRONOMY/ ORION AT71/ COVE BASE P-36C9TB/ 6" X 12"
WALL		
PT-1	FIELD PAINT	PPG/ 1007-1 WILLOW SPRING/ EGGSHELL FINISH TYPICAL/ SEMI-GLOSS FINISH AT CMU AND INTERIOR BRICK WALLS/ EPOXY FINISH AT WET AREAS
PT-2	ACCENT PAINT	PPG/ 1152-3 GRACEFUL/ EGGSHELL FINISH TYPICAL/ SEMI - GLOSS FINISH AT CMU AND INTERIOR BRICK WALLS
PT-3	ACCENT PAINT	PPG/ 1163-2 MEMORY LANE/ EGGSHELL FINISH TYPICAL/ SEMI - GLOSS FINISH AT CMU AND INTERIOR BRICK WALLS
PT-4	ACCENT PAINT	PPG/ 1152-4 AMERICANA/ EGGSHELL FINISH TYPICAL/ SEMI - GLOSS FINISH AT CMU AND INTERIOR BRICK WALLS
PT-5	PAINT TO MATCH EXISTING	PPG/ TO MATCH EXISTING ADJACENT COLOR AND FINISH/ PROVIDE MOCK UP SAMPLE FOR REVIEW AND APPROVAL BY ARCHITECT AND OWNER PRIOR TO PURCHASING
CWT-1	CERAMIC WALL TILE	DALTILE/ COLOR WHEEL/ 0100 WHITE/ 6" X 6" X 5/16"/ GROUT: EPOXY GROUT/ COLOR TO BE SELECTED FROM MANUFACTURER'S FULL COLOR LINE/ 3/16" GROUT JOINT
CWT-2	CERAMIC WALL TILE (ACCENT)	DALTILE/ CONFECTIONARY/ BLUEBERRY COBBLER CY28/ 6" X 6" X 5/16"/ GROUT: EPOXY GROUT/ COLOR TO BE SELECTED FROM MANUFACTURER'S FULL COLOR LINE/ 3/16" GI JOINT
MILLWORK		
PL-1	LAMINATE	WILSONART LAMINATE/ STUDIO TEAK 7960K-18
PL-2	LAMINATE	WILSONART LAMINATE/ SAP WALNUT 8221-38
PL-3	LAMINATE	WILSONART LAMINATE/ ORGANIC COTTON 4674-38
SS-1	SOLID SURFACE	BPI/ DURASEIN/ DM508 BIANCA SABBIA / 1/2" THICK
MW-1	LOCKER ROOM MILLWORK	
	COUNTERTOP AND BACKSPLASH	SS-1: BPI/ DURASEIN/ DM508 BIANCA SABBIA / 1/2" THICK/ EASED EDGE/ INTEGRAL 4" BACKSPLASH
	APRON	PL-1: WILSONART LAMINATE/ STUDIO TEAK 7960K-18
MW-2	TYPICAL MILLWORK	
	COUNTERTOP AND BACKSPLASH	PL-3: WILSONART LAMINATE/ ORGANIC COTTON 4674-38/ 4" BACKSPLASH
	LOWER AND/OR UPPER CABINETS	PL-2: WILSONART LAMINATE/ SAP WALNUT 8221-38
MW-3	RECEPTION DESK MILLWORK	
	COUNTERTOP AND BACKSPLASH	SS-1: BPI/ DURASEIN/ DM508 BIANCA SABBIA / 1/2" THICK/ EASED EDGE/ INTEGRAL 4" BACKSPLASH AS NECESSARY
	BASE CABINETS AND DESK FRONT	PL-2: WILSONART LAMINATE/ SAP WALNUT 8221-38
CEILING		
PTD. GYP.	PAINTED GYPSUM BOARD	5/8" GYPSUM BOARD AS SPECIFIED TO RECEIVE COLOR PT-1: PPG/ 1007-1 WILLOW SPRING/ FLAT FINISH TYPICAL/ EPOXY FINISH AT WET AREAS
ACT-1	ACOUSTICAL CEILING TILE	ARMSTRONG CEILINGS/ ULTIMA/ 15/16" SQUARE LAY-IN/ 1943 / COLOR: WHITE/ 24" X 48" X 7/8" THICK/ USE MANUFACTURER RECOMMENDED CEILING GRID
ACT-2	ACOUSTICAL CEILING TILE (WET AREAS)	ARMSTRONG CEILINGS/ ULTIMA HEALTH ZONE/ 15/16" SQUARE LAY-IN/ 1938 / COLOR: WHITE/ 24" X 48" X 3/4" THICK/ USE MANUFACTURER RECOMMENDED CEILING GRID
OTHER		
	2-TIER LOCKERS	SCRANTON/ TUFTEC LOCKERS/ RECREATIONAL LOCKERS/ COLOR: TO BE SELECTED FROM MANUFACTURER'S FULL COLOR RANGE/ 18" X 18" X 72" TOTAL HEIGHT
	TOILET PARTITIONS	SCRANTON/ HINY HIDERS/ COLOR: BRUSHED STAINLESS STEEL/ FLOOR MOUNTED OVER-HEAD BRACED/ STAINLESS STEEL HARDWARE
PT-6	DOOR AND DOOR FRAME PAINT	PPG/ TO MATCH EXISTING ADJACENT COLOR/ SEMI - GLOSS FINISH
ELEV. PANEL	INTERIOR ELEVATOR PANELS	THYSSENKRUPP/ STANDARD POWDER COATED INTERIOR PANELS/ BLUE PATINA F-130
;	SULID SUKFACE FLOOR THRESHOLD	WILSONART/ 1573SL(1) FROSTY WHITE/ THICKNESS PER MANUFACTURER'S RECOMMENDATIONS/ REFERENCE THRESHOLD DETAIL 11/A4.3

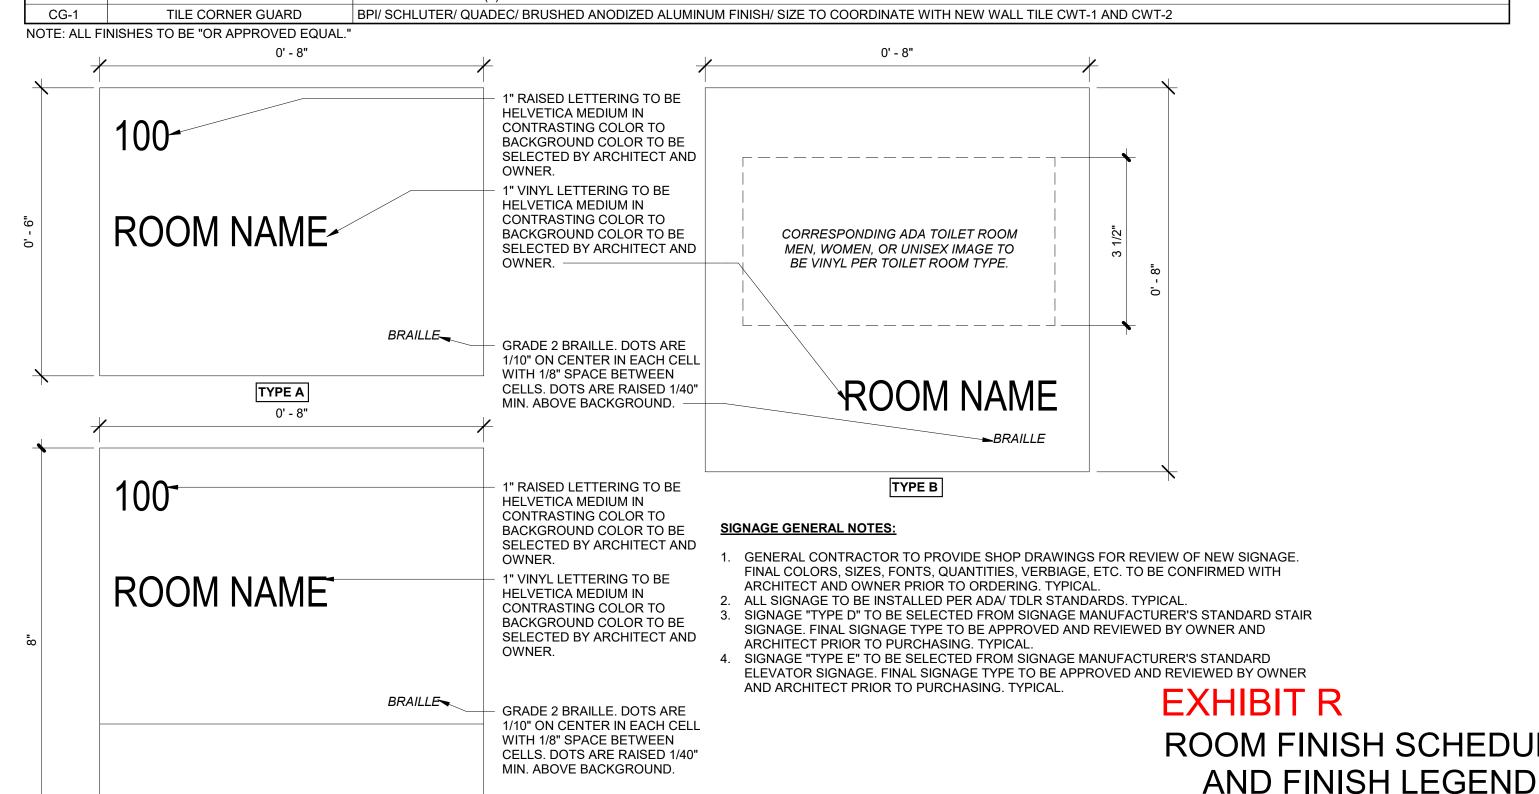

SLOT FOR PAPER INSERT

TYPE C

SIGNAGE TYPES

SCALE: 6" = 1'-0"


ROOM FINISH SCHEDULE

OF CHESNEY MORALES PARTNERS, INC.


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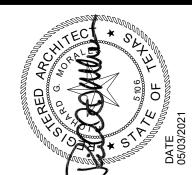
**Revision Schedule** Description

ADD #01 5/3/2021

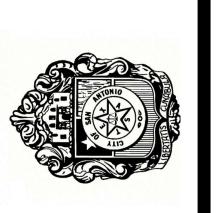


JOB NO: 02/05/2021 DRAWN BY: CHECKED BY:



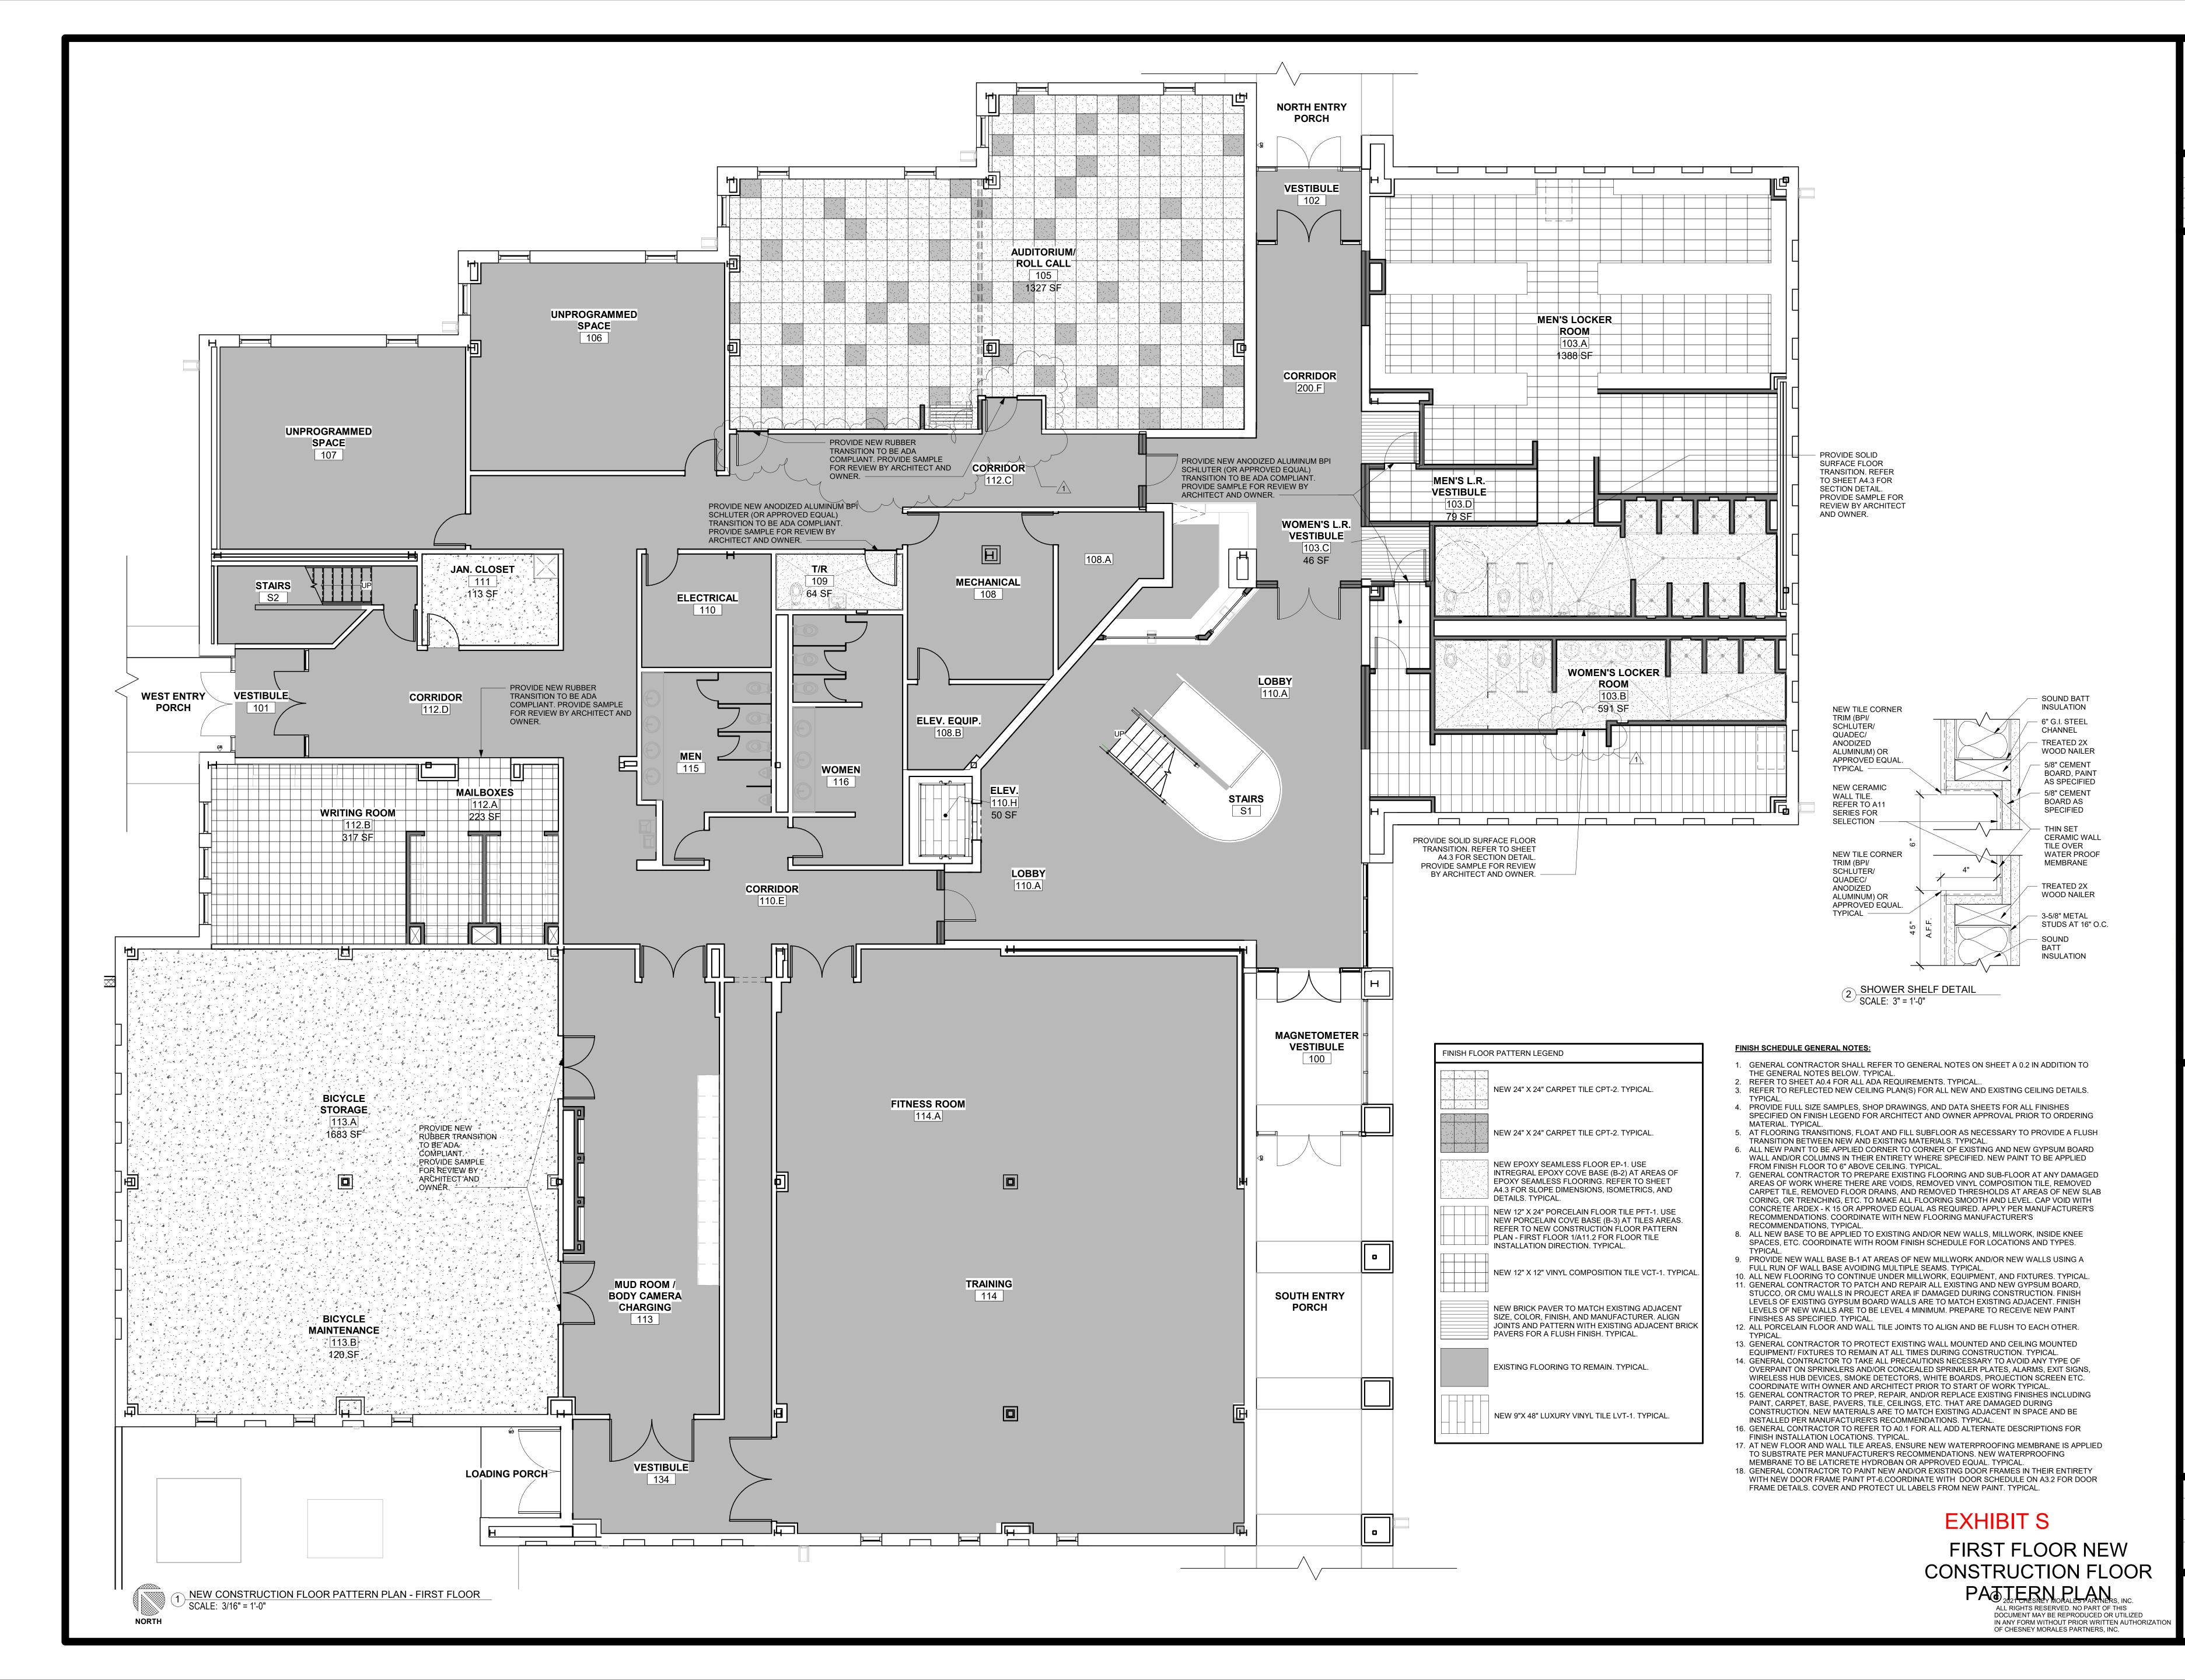

**Revision Schedule** Description Date ADD #01 5/3/2021

JOB NO: 05/03/2021 DRAWN BY: CHECKED BY: CMF

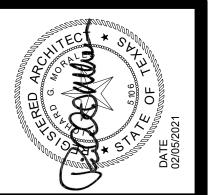

Description Date ADD #01 5/3/2021



JOB NO: 02/05/2021 DRAWN BY:


SHEET

CHECKED BY:

**EXHIBIT T** SECOND FLOOR NEW CONSTRUCTION FLOOR

PATTERN PLAN
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NORTH

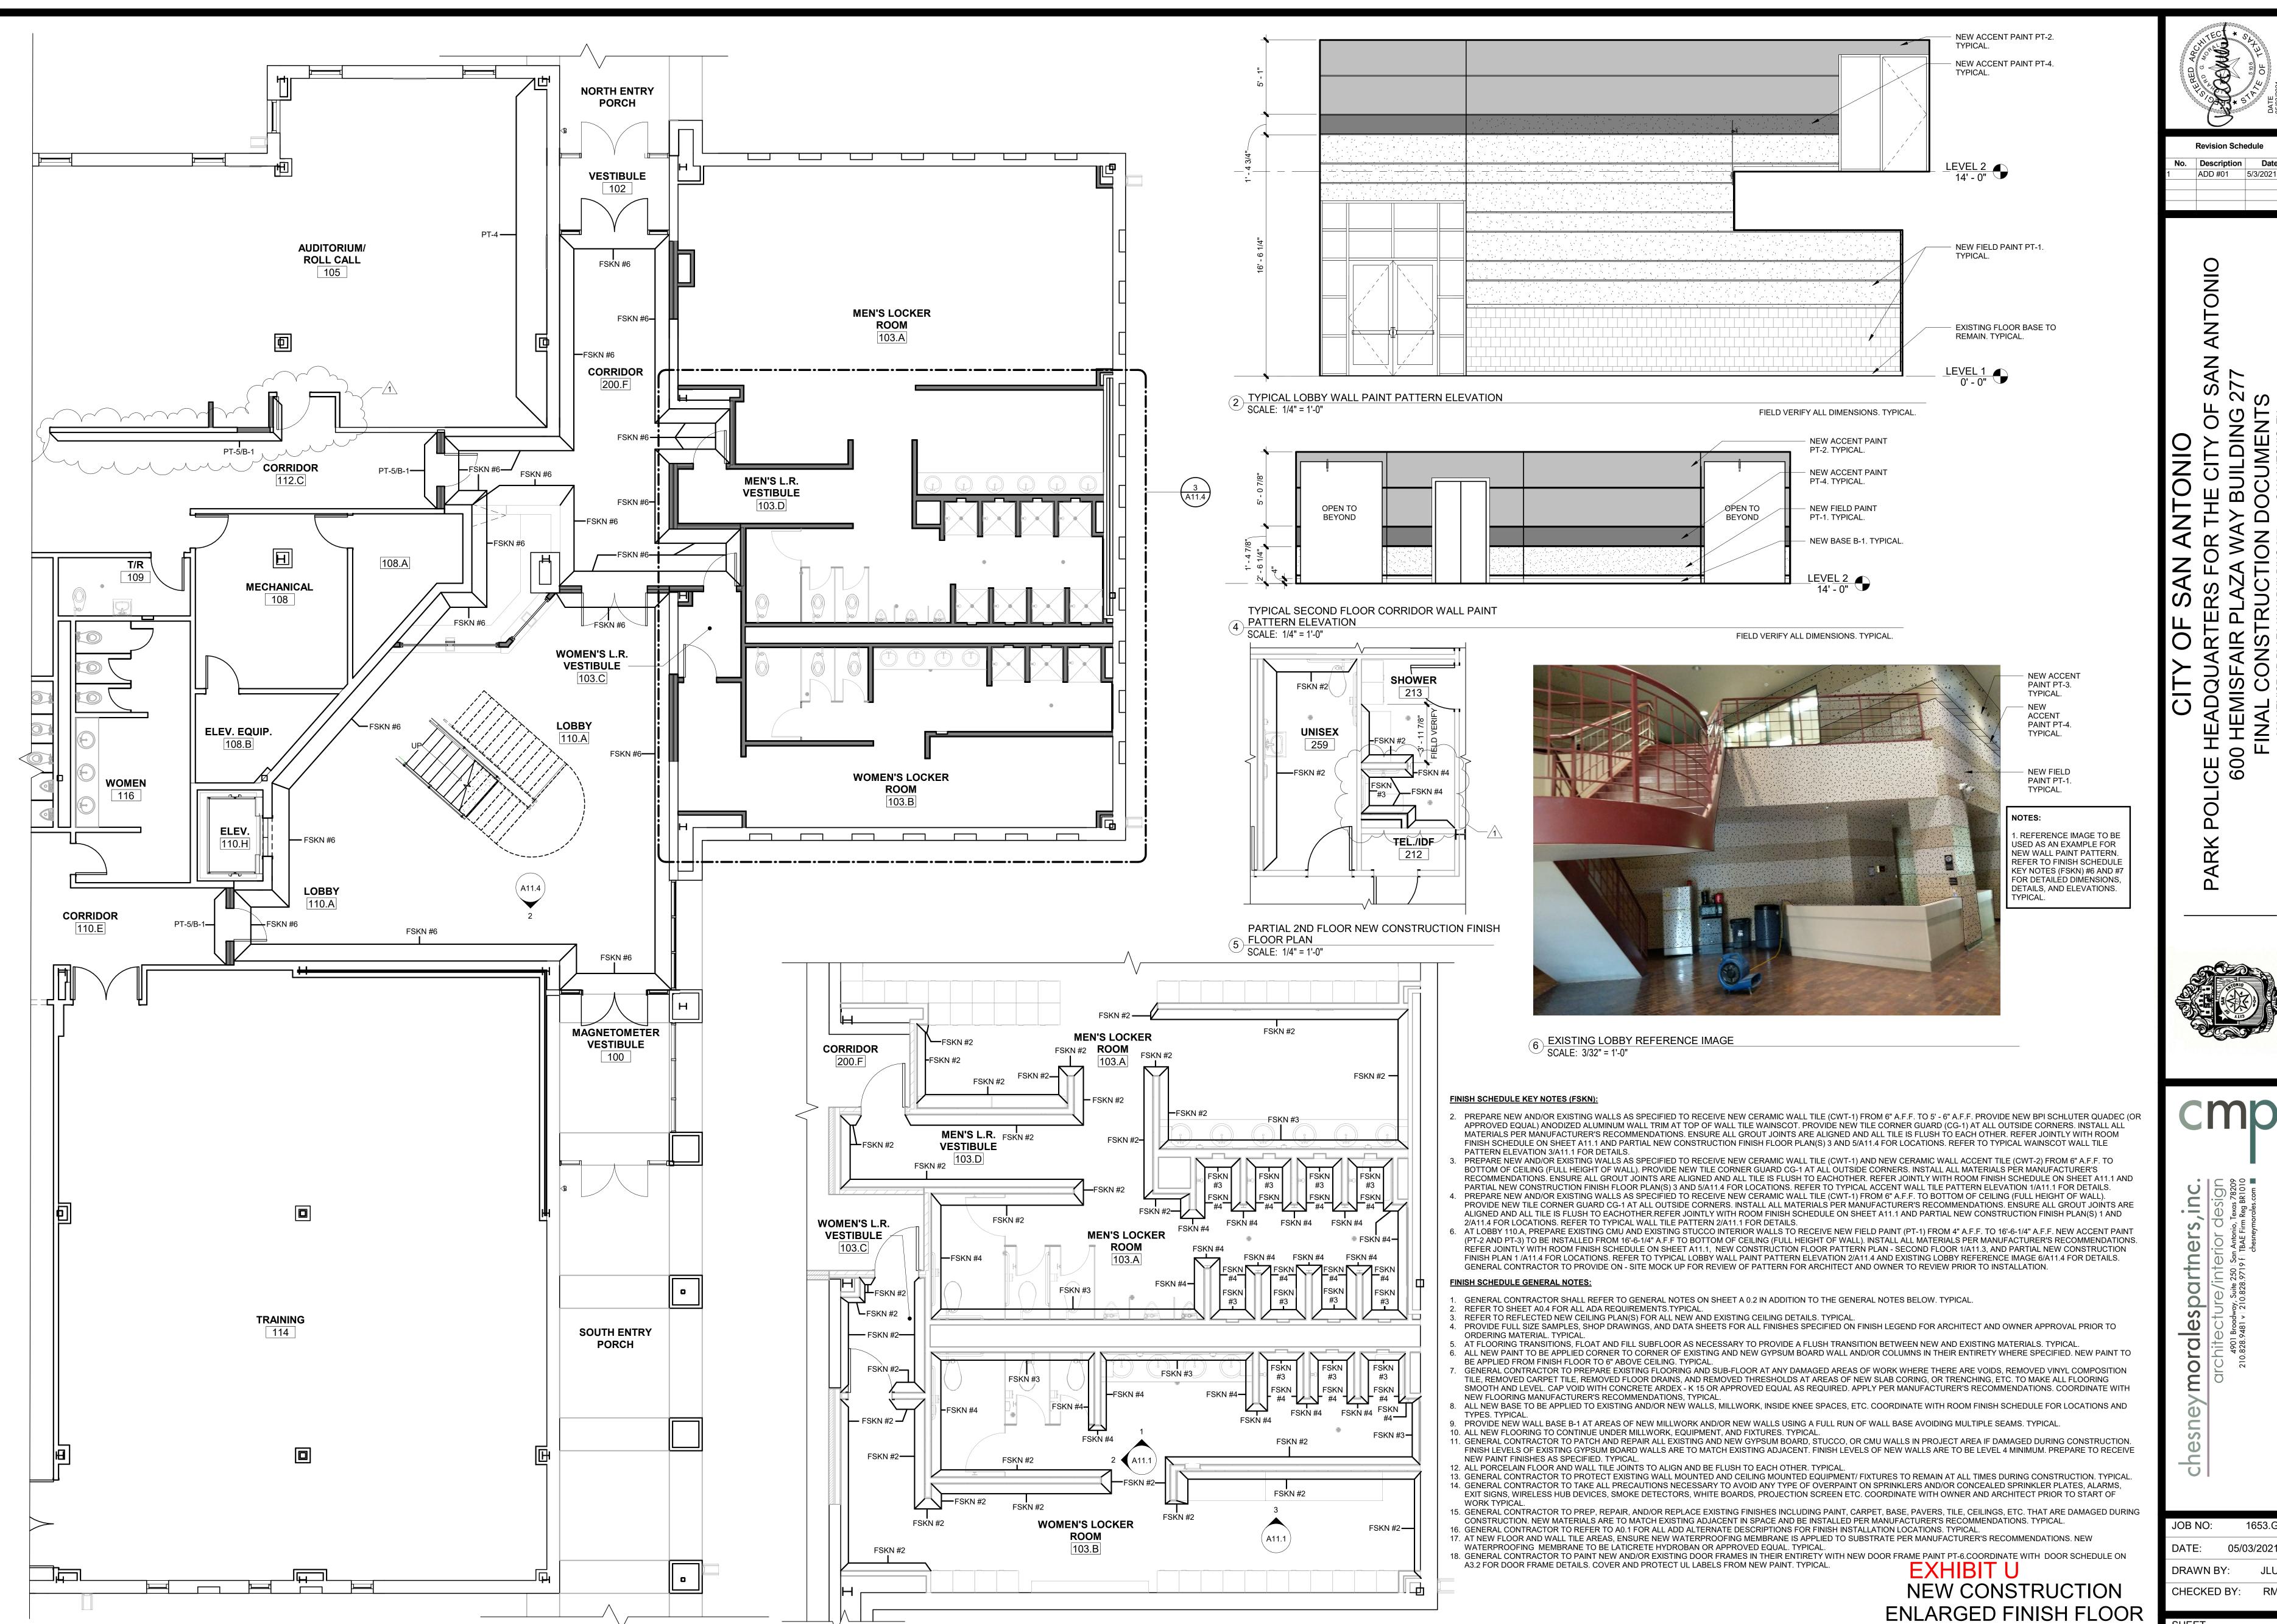

**ENLARGED 1ST FLOOR NEW CONSTRUCTION FINISH** 

3 FLOOR PLAN - LOCKER ROOMS
SCALE: 1/4" = 1'-0"

PARTIAL NEW CONSTRUCTION FINISH FLOOR PLAN - FIRST FLOOR

SCALE: 3/16" = 1'-0"

NORTH

**Revision Schedule** 

Description Date ADD #01 5/3/2021

JOB NO: 05/03/2021 DRAWN BY:

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### **Addendum Number 1**

May 3, 2021

To Drawings and Specifications dated February 5, 2021

City of San Antonio
Park Police Headquarters
Hemisfair Plaza
San Antonio, Texas

Prepared for: Chesney Morales Partners, Inc.

4901 Broadway, Suite 250 San Antonio, Texas 78209

#### **DRAWINGS**:


1. S1.2 EXISTING SECOND FLOOR FRAMING PLAN

a. On the west side small roof plan, added EF-2.

2. S1.3 EXISTING ROOF FRAMING PLAN

a. Added RH-2, RH-6, RH-7, CU-5, CU-6 and EF-1.

**END OF ADDENDUM No. 1** 

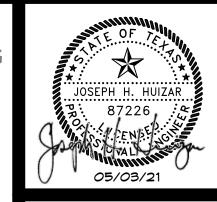

**Revision Schedule** Description Date Addendum 1 05-03-21

ANTONIO

JOB NO: DATE: 02/05/2021

DRAWN BY: IES Staff CHECKED BY: JHH


EXISTING SECOND FLOOR

FRAMING PLAN

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INTELLIGENT ENGINEERING SERVICES, LLP MAKES NO GUARANTEE CONCERNING THE ACCURACY OF THE INFORMATION CONTAINED HEREIN.

6. SHORE EXISTING STRUCTURE AS REQUIRED PRIOR TO ANY MODIFICATIONS.

7. FIELD VERIFY DIMENSIONS OF EXISTING CONSTRUCTION AND COORDINATE

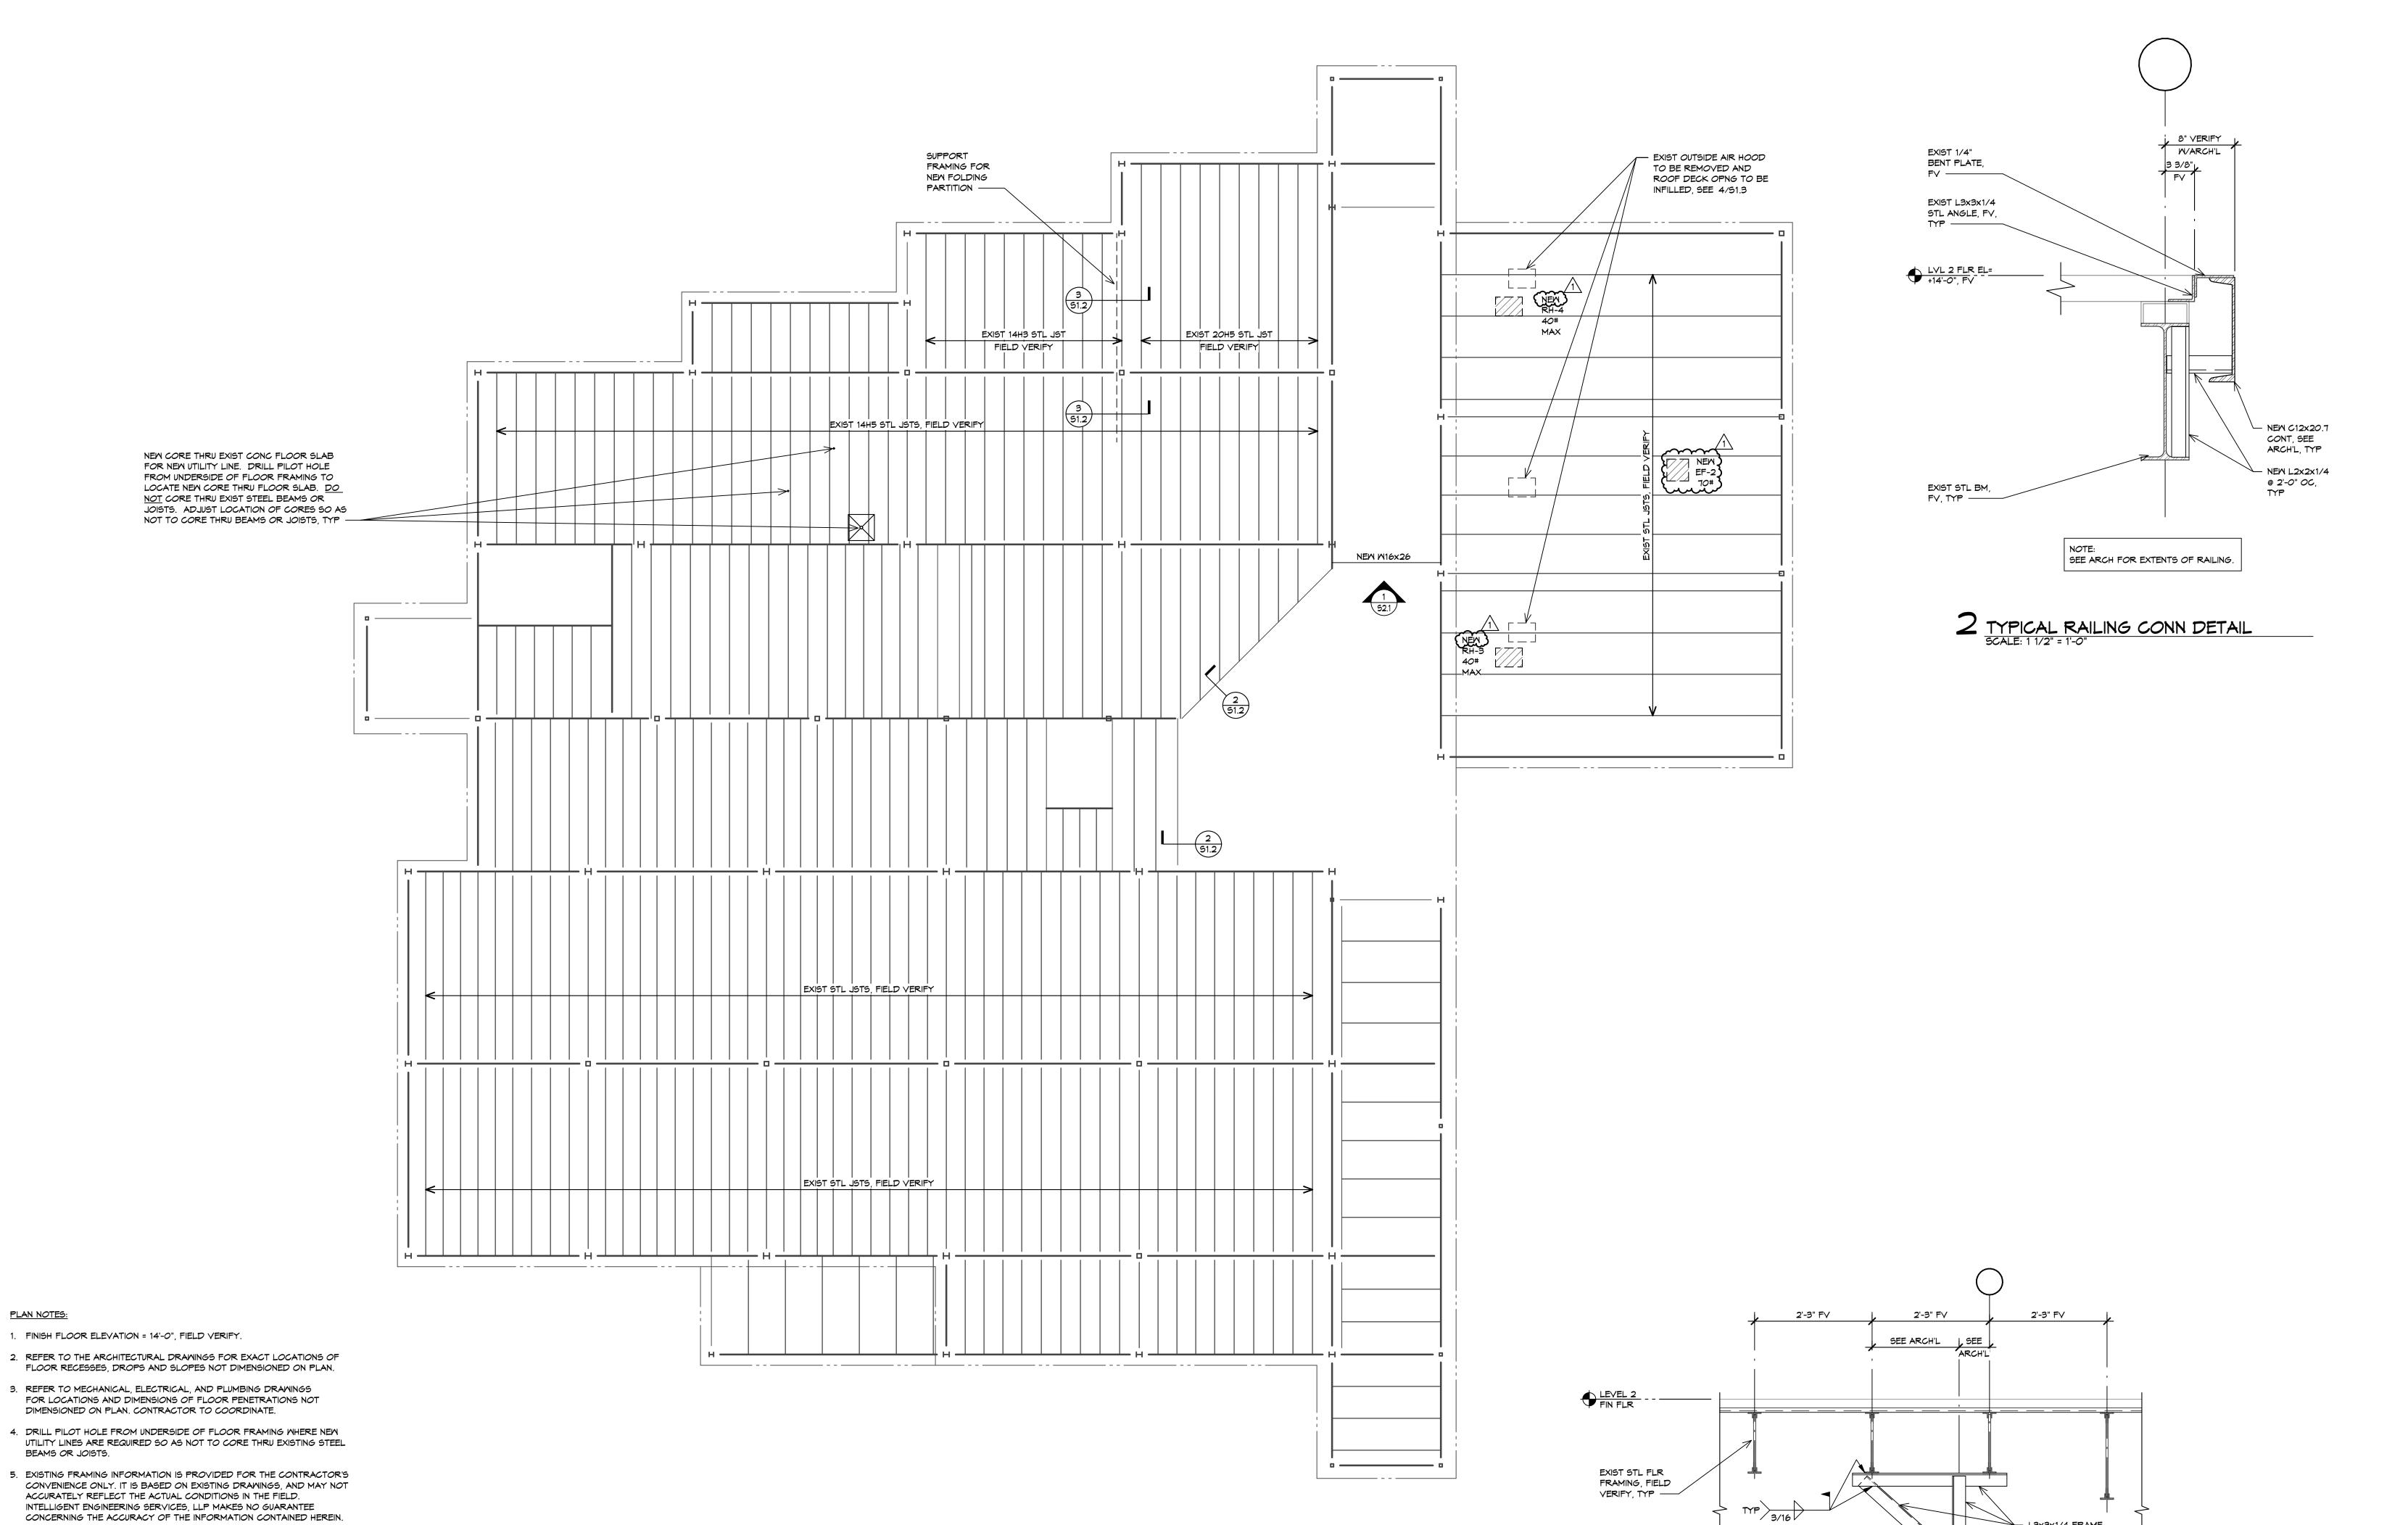WITH DIMENSIONS OF NEW CONSTRUCTION. NOTIFY ARCHITECT AND

ENGINEER OF ANY DISCREPANCIES OR CNFLICTS.

FIELD VERIFY ALL CONDITIONS.

SEE EQUIP'T\_ SUPPLIER FOR ELEV

CLG HT = 9'-9", VERIFY WARCH'L

L3x3x1/4 CLIP ANGLE @ 4 EA

FRAME -

L3x3x1/4 FRAME

EA END AND @ 4'-0" OC MAX

- C8x11.5 CONT

FINAL

NOTE: APPLIES TO OPENINGS 12" OR LARGER

FRAMING FOR MECHANICAL 2 OPENINGS THRU ROOF DECK

SCALE: 3/4" = 1'-0"


20H7 STL

EXIST 22H8 STL JST, FV

EXIST 20H7 STL JST

EXIST N16x31

í 638#<sup>1</sup>

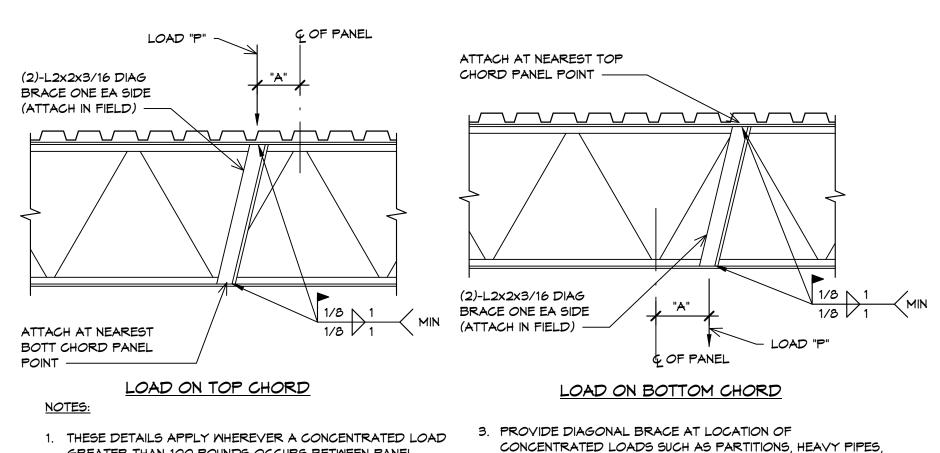


GREATER THAN 100 POUNDS OCCURS BETWEEN PANEL POINTS OF TRUSS OR JOIST CHORDS. 2. DIAGONAL BRACE IS NOT REQUIRED FOR "A" LESS THAN THREE INCHES.

 PROVIDE DIAGONAL BRACE AT LOCATION OF CONCENTRATED LOADS SUCH AS PARTITIONS, HEAVY PIPES, MECHANICAL UNITS, HEAVY LIGHTS, SPORTS EQUIPMENT AND ANY OTHER CONCENTRATED LOADS.

4. P = CONCENTRATED LOAD.

5. FOR POINT LOADS 200 POUNDS MAX, LOADS GREATER THAN 200 POUNDS WILL BE NOTED ON PLANS.

3 TYPICAL JOIST CHORD REINFORCEMENT DETAIL
SCALE: 3/4" = 1'-0"

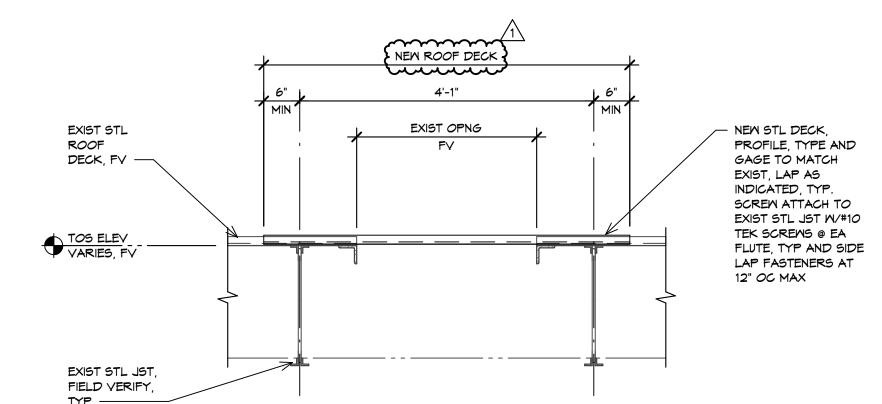

4 EXISTING ROOF OPENING INFILL DETAIL

SCALE: 3/4" = 1'-0"



EXISTING ROOF FRAMING PLAN

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CHECKED BY: JHH SHEET

JOB NO:

DATE: 02/05/2021

DRAWN BY: IES Staff

IN ANY FORM WITHOUT PRIOR WRITTEN AUTHORIZATION OF CHESNEY MORALES PARTNERS, INC.

EXIST 14H5 STL JST, FV

440#

EXIST M18x35

RH-1 440# MAX

NEM OUTSIDE AIR HOOD, SEE MEP

SERIES DWGS, TYP -

NEW OUTSIDE AIR HOOD, SEE MEP SERIES DWGS, TYP

- EXIST OUTSIDE AIR HOOD

TO BE REMOVED AND ROOF DECK OPNG TO BE INFILLED, SEE 4/S1.3

NEW NH-6 35#

turium turi

EXIST 24H8 STL JST, FV

EXIST 20H7 STL JST, FV

NEW CU-6

NEM CU-5

EXIST M18x35

NEW 11 NEW 1 NEW 1

L/\_/**|** 35#





1344 S. Flores, Ste. 101, San Antonio, Texas 78204 P: 210.447.6100 | TBPE No. F-9357

#### Addendum No. 001

Project: CoSA Park Police Headquarters

Project No. 200027

Date: 5/3/2021

This Addendum forms a part of the Contract Documents. This addendum modifies and supplements the Contract Documents as described herein for the afore referenced Project and includes:

- Two- (2-) page narrative
- Zero (0) attachment(s)
- Nine (9) revised drawing sheets



05/03/2021

#### **Changes to Drawings**

#### Mechanical

- 1. Sheet MD102 Second Floor Plan Demolition (See revised drawing)
  - a. Revised the name of Room 215 to be "Office 215".
- 2. Sheet M102 Second Floor Plan Mechanical (See revised drawing)
  - a. Revised the name of Room 215 to be "Office 215".

#### **Electrical**

- 1. Sheet E102 Second Floor Electrical Lighting Plan (See revised drawing)
  - a. Revised the name of Room 215 to be "Office 215".
- 2. Sheet E202 Second Floor Electrical Power Plan (See revised drawing)
  - a. Revised the name of Room 215 to be "Office 215".
- 3. Sheet EM202 Second Floor Mechanical Power Plan (See revised drawing)
  - a. Revised the name of Room 215 to be "Office 215".
- 4. Sheet E302 Second Floor Special Systems Floor Plan (See revised drawing)
  - a. Revised the name of Room 215 to be "Office 215".
- 5. Sheet E501 Electrical Schedules (See revised drawing)
  - a. Revised Lighting Fixture Schedule. [For clarity, unused lighting fixture Types A5, B, B4, C2, D2, and D4 were deleted.]
- 6. Sheet E503 Electrical Schedules (See revised drawing)
  - a. Revised the schedule for Panel P2A" for descriptions of indicated spare circuit breakers being repurposed for active use.

#### **Plumbing**

- 1. Sheet P102 Plumbing Second Floor Plan (See revised drawing)
  - a. Revised the name of Room 215 to be "Office 215".




#### **Technology**

- 1. Sheet T2.2, Technology Floor Plan Level 2 (narrative only)
  - a. Revised the name of Room 215 to be "Office 215".

#### **Changes to Specifications**

- 1. Section 26 2310, Packaged Engine Generators (narrative only)
  - a. Paragraph 2.1, A: Add "Taylor Power" to the list of acceptable manufacturers.

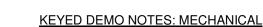

- DEMOLISH AND REMOVE VARIABLE VOLUME FAN POWERED BOX WITH ELECTRIC RE-HEAT AND CONTROLS BACK TO SOURCE, INCLUDE THE SUPPLY TAP BACK TO THE MAIN SUPPLY DUCT. REFER TO NEW WORK.
- DEMOLISH AND REMOVE AIR HANDLER IN IT'S ENTIRETY INCLUDING CONTROLS, CHILLED WATER PIPING, AND DUCTWORK AS INDICATED. REFER TO NEW WORK.
- 3 DEMOLISH AND REMOVE DUCTWORK AS INDICATED. REFER TO NEW WORK.
- (4) EXISTING DUCTWORK TO REMAIN. REMOVE INSULATION, REFER TO NEW WORK.

**Revision Schedule** 

Description Date Addendum #1 05/03/21





JOB NO: 200027(cz) DATE: 02/05/2021

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SHEET MD102



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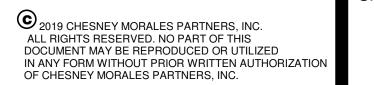
ENGINEERS

1 SECOND FLOOR PLAN - DEMOLITION

MD102 1/8" = 1'-0"


0' 4' 8' 16'

SCALE: 1/8"=1'-0"



02/05/2021 DATE: DRAWN BY: Author CHECKED BY:Checker

SHEET

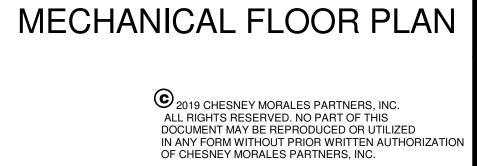



## KEYED NOTES: MECHANICAL

- 1 EXISTING RETURN AIR SOUND ATTENUATORS ABOVE THE CEILING TO REMAIN. 2 EXISTING SUPPLY AIR DUCT TO REMAIN. ALL EXISTING DUCTWORK SHALL BE RE-INSULATED
- PROVIDE AND INSTALL VARIABLE VOLUME FAN POWERED BOX WITH ELECTRIC REHEAT. RECONNECT DUCTWORK, TRANSITION AND OFFSET AS REQUIRED, SEAL DUCT AIR TIGHT. ALL CONTROLS SHALL BE NEW DDC CONTROLS, REFER TO CONTROLS DIAGRAMS. (TYPICAL)
- PROVIDE AND INSTALL WALL MOUNTED FAN AND COIL UNIT. REFER TO SCHEDULE AND DETAIL ROUTE 3/4" INSULATED PUMPED COPPER CONDENSATE TO JANITORS SINK AS INDICATED. 5 PROVIDE AND INSTALL TEMPERATURE SENSOR, MOUNT AT ADA HEIGHT.
- 6 PROVIDE AND INSTALL RELIEF AIR DUCT UP TO RELIEF HOOD ON ROOF, REFER TO SCHEDULE. PROVIDE MOTORIZED CONTROL DAMPER. INCLUDE FULL SIZE ELBOW UP SOUND BOOT.



RA





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E102





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# SECOND FLOOR ELECTRICAL LIGHTING PLAN SHEET

35 FC REF 2/E103 1%

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SECOND FLOOR LIGHTING PLAN

1/8" = 1'-0"

8.19 1)0

A3
APPLICANTs

REQUIRED ILLUMINATION AND LIGHTING CONTROL AVG (+/-5 FC ) WIRING DIAGRAM DIMMING ADMIN ASSISTANT & ADMIN FILES 211 REF 4/E103 ADMIN SERGEANTS OFFICE (FUTURE) 207 REF 4/E103 ADMIN SERGEANTS OFFICE 202 REF 4/E103 1% ADMINISTRATIVE WORKSPACE 253 REF 4/E103 1% APPLICANT PROCESSING STORAGE 205 REF 1/E103 N/A APPLICANT PROCESSING ROOM 204 REF 2/E103 1% BREAK ROOM 216
CAPTAINS OFFICE 210
CONFERENCE ROOM 214 20 FC REF 1/E103 N/A 50 FC REF 2/E103 1% REF 6/E103 1% CORE SQUAD ROOM 1 226 REF 2/E103 1% CORE SQUAD ROOM 2&3 233 CORE SQUAD ROOM 4 227 REF 2/E103 1% REF 2/E103 1% REF 5/E103 N/A CORRIDORS ELECTRICAL / IDF 223 40 FC REF 4/E103 1%
40 FC REF 2/E103 1%
35 FC REF 4/E103 1% FLEET OFFICE 234 HR OFFICE / WAITING 201 INTERNAL AFFAIRS 250 INTERNAL AFFAIRS 251 REF 4/E103 NTERNAL AFFAIRS 252 REF 4/E103 1% REF 3/E103 N/A LIEUTENANT OFFICE (DISTRICTS) 203 LIEUTENANT OFFICE (RIVER) 209 LIEUTENANT OFFICE (FUTURE) 254 REF 4/E103 1% REF 2/E103 1% 35 FC REF 4/E103 1% MECHANICAL 217 25 FC REF 1/E103 N/A MEN RESTROOM 220 REF 5/E103 N/A REF 4/E103 1% OFF DUTY EMPLOYMENT OFFICE 228 STAIRS S2 REF 5/E103 N/A QUIET LACTATION ROOM 215 REF 4/E103 1% READY ROOM 257 REF 2/E103 1% RESEARCH & PLANNING OFFICE 232
SQUADROOM FILE AREA (DISTRICTS) 243
SQUADROOM FILE AREA (RIVER) 256 45 FC REF 2/E103 1%
35 FC REF 4/E103 1%
45 FC REF 2/E103 1%
45 FC REF 2/E103 1%
40 FC REF 4/E103 1% SQUADROOM FILE AREA / CORE SUPERVISORS OFFICE 225
SERGEANTS WORKSTATION (RIVER) 1 237
SERGEANTS WORKSTATION (RIVER) 2 241 REF 4/E103 1% ERGEANTS WORKSTATION (RIVER) 3 240 REF 4/E103 1% ERGEANTS WORKSTATION (RIVER) 4 239 SERGEANTS WORKSTATION (RIVER) 5 238 REF 4/E103 1% SERGEANTS WORKSTATION (RIVER) 6 235 40 FC REF 4/E103 1% SERGEANTS WORKSTATION (DISTRICTS) 1 249 40 FC REF 4/E103 1% SERGEANTS WORKSTATION (DISTRICTS) 2 248 REF 4/E103 SERGEANTS WORKSTATION (DISTRICTS) 3 247 SERGEANTS WORKSTATION (DISTRICTS) 4 246
SERGEANTS WORKSTATION (DISTRICTS) 5/WORK ROOM 243 REF 2/E103 1% REF 2/E103 1% SERGEANTS WORKSTATION (DISTRICTS) 6 242 REF 4/E103 1% SHOWER 213 STORAGE 219 STORAGE 255 TELEPHONE / IDF 212 UNDER COVER OFFICE 230 UNDER COVER OFFICE 231 REF 4/E103 UNDER COVER STORAGE 229 UNISEX 259 WOMEN RESTROOM 222 REF 5/E103 N/A

## **GENERAL NOTES:**


WORK ROOM 206


- A. NEW LIGHTS SHALL CONNECT TO THE EXISTING 277V LIGHTING CIRCUITS. EXTEND CONDUIT AND WIRING AS REQUIRED FOR NEW FIXTURE LOCATIONS.
- B. PROVIDE NEW LOW VOLTAGE CONTROLS FOR INDOOR LIGHTS AND WHERE NEW

C. WHERE NEW LIGHTING CONTROLS ARE NOT SHOWN, NEW LIGHTS SHALL RECONNECT TO THE EXISTING CONTROLS.

DATE: DRAWN BY: CHECKED BY: TD

SHEET E202

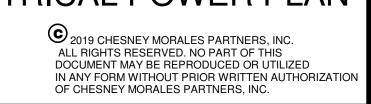

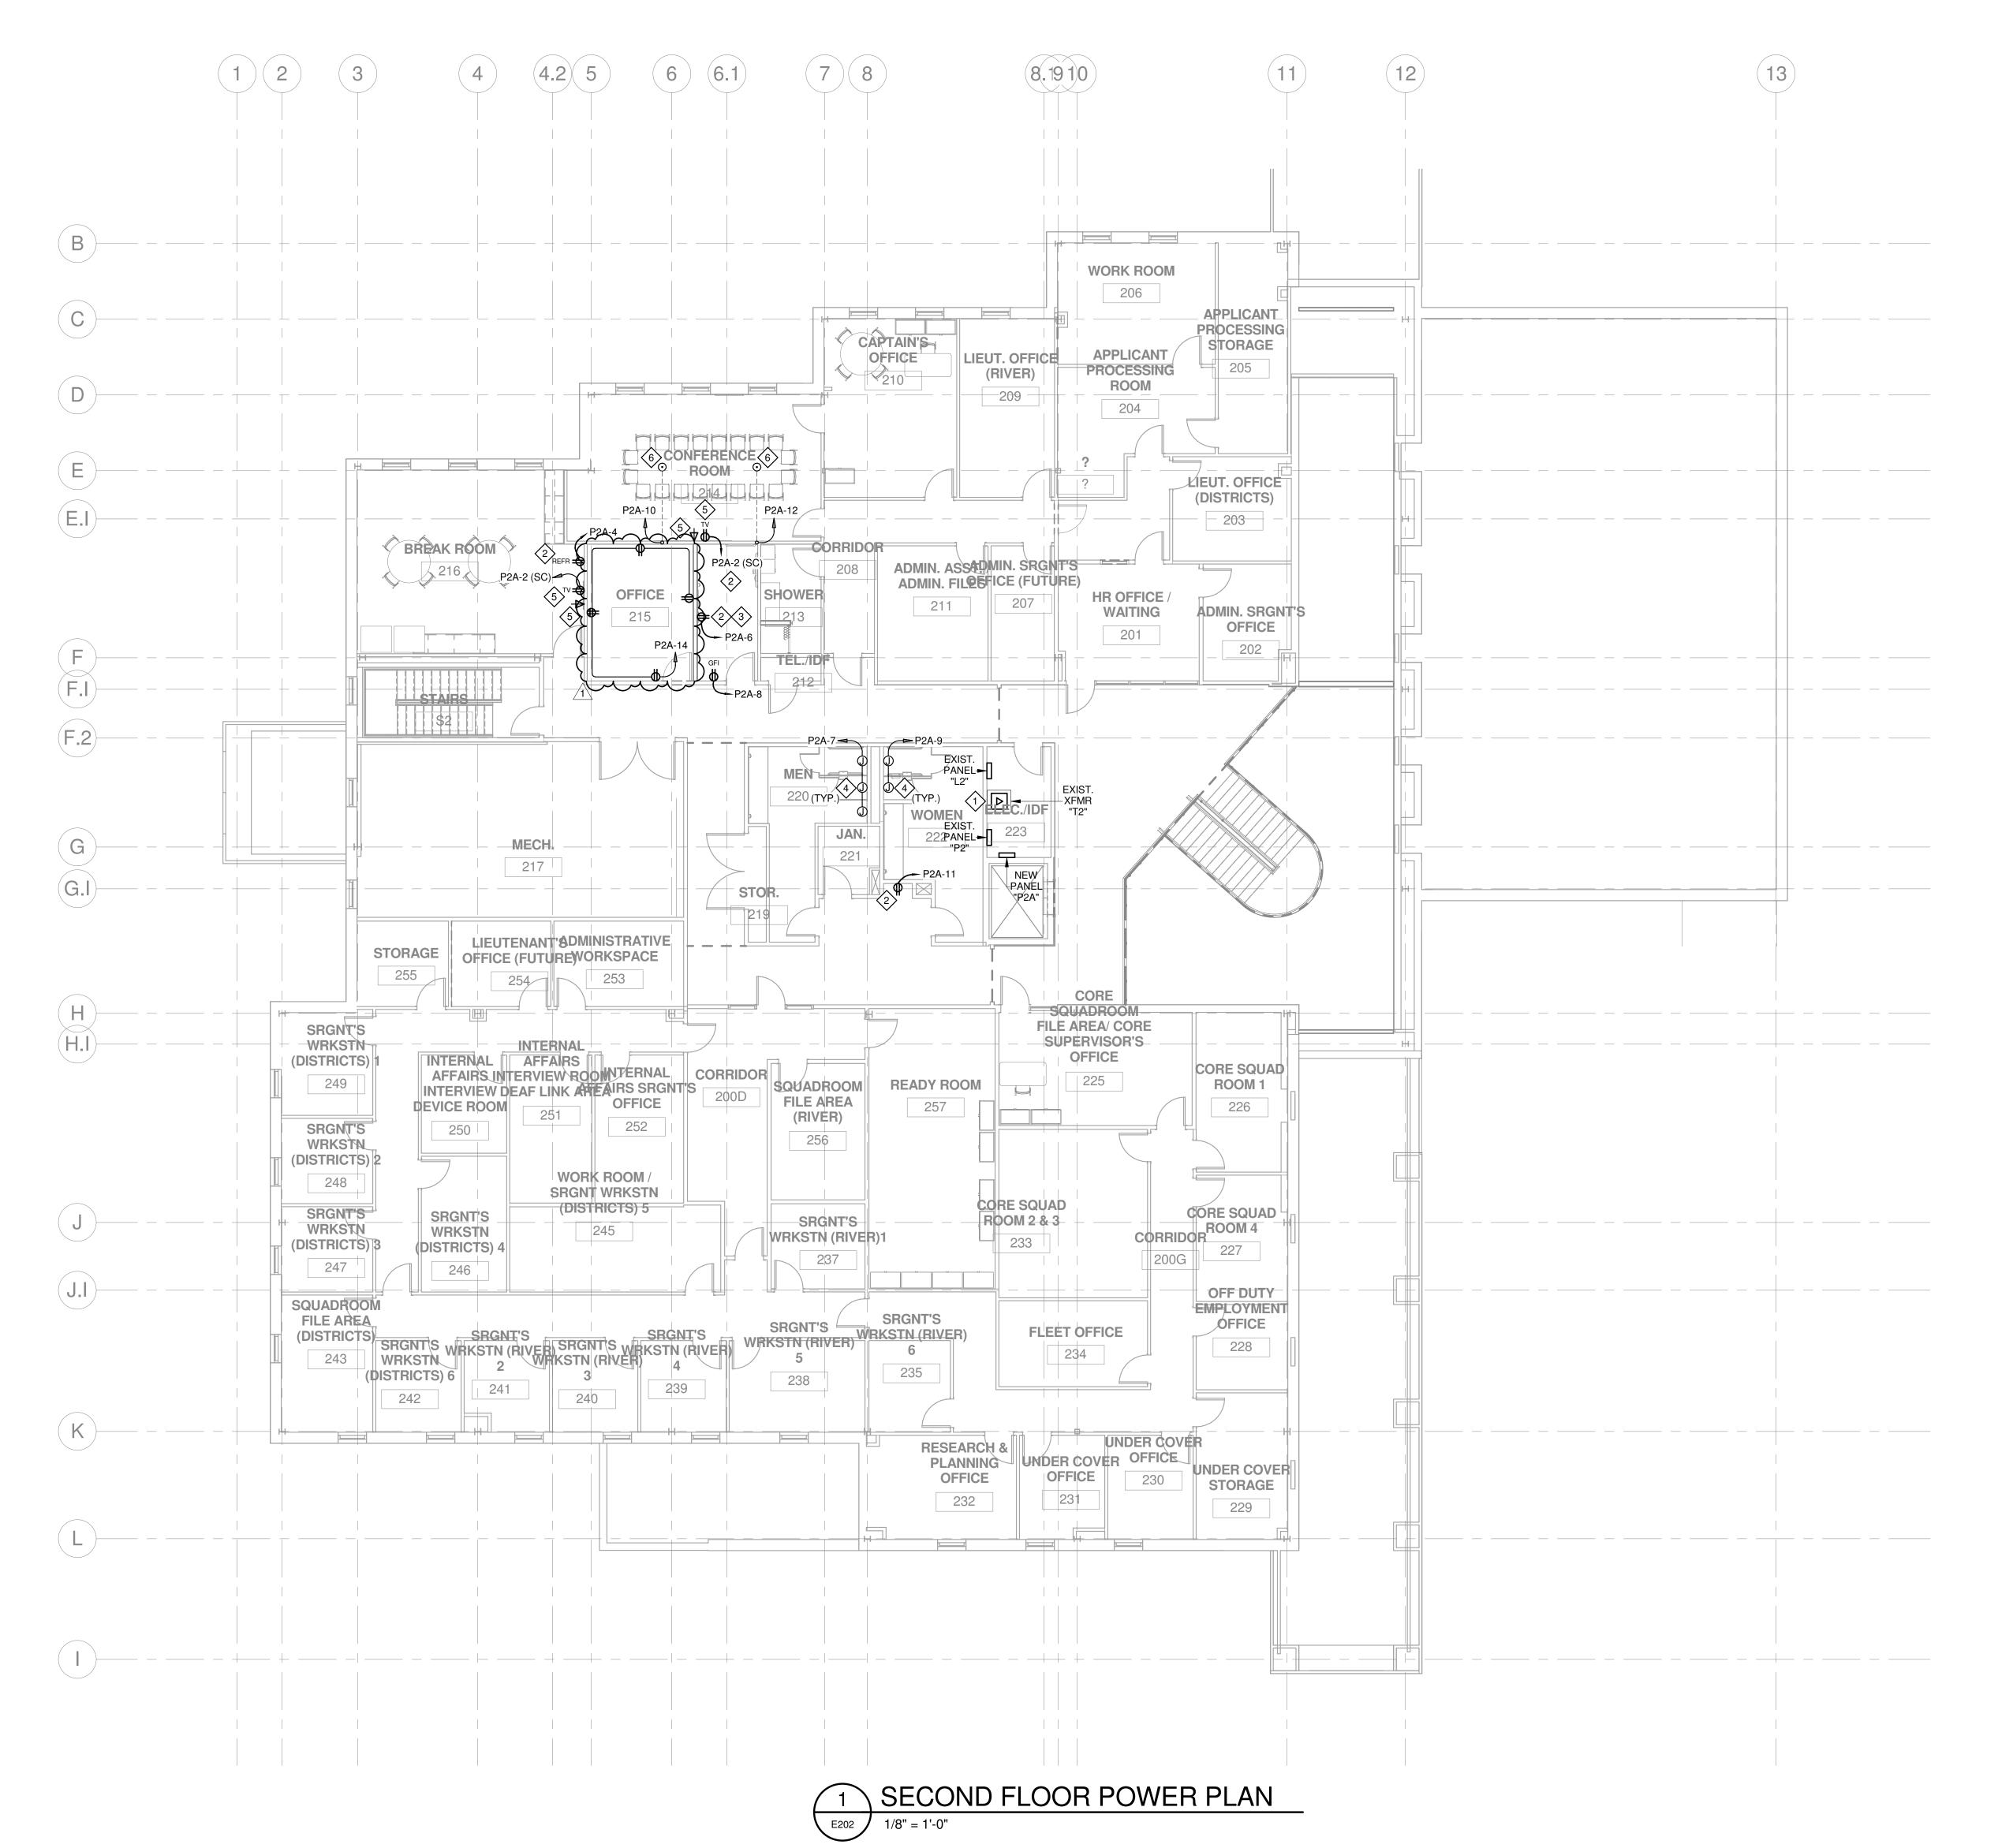

**ELECTRICAL GENERAL NOTES:** 

**KEYED NOTES:** 

B. NEW LOADS ARE CONNNECTED TO NEW CIRCUITS.

1 EXISTING 45kVA TRANSFORMER TRAPEZE MOUNTED.

6 POKE-THRU WITH TWO NEMA 5-20R DUPLEX RECEPTACLES.

A. EXISTING RECEPTACLES AND RELATED CIRCUITS THAT ARE LOCATED ON WALLS THAT ARE EXISTING TO REMAIN ARE NOT SHOWN.

PROVIDE NAMEPLATE READING "PROTECTED BY GFI CIRCUIT BREAKER".

> COORDINATE OUTLET LOCATION AS DIRECTED BY ARCHITECT FOR TOWEL DISPENSER.

COORDINATE EXACT HEIGHT AND LOCATION WITH PLUMBING FIXTURE FOR AUTOMATIC VALVE.

COORDINATE EXACT LOCATION AND ELEVATION WITH OWNER PRIOR TO ROUGH-IN.

TRUE NORTH PLAN NORTH SCALE: 1/8"=1'-0"





SECOND FLOOR
MECHANICAL POWER PLAN
SHEET

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T.L. DAWSEY

66035

CENSS

05/03/2021

Revision Schedule

Revision Schedule

No. Description Date

Addendum 05/03/21 #1

Addendum 05/0 #1

CITY OF SAN ANTONIO
E HEADQUARTERS FOR THE CITY OF SAN ANTC



ymoralespartners,inc.

architecture/interior design
4901 Broadway, Suite 250 | San Antonio, Texas 78209
210.828.9481 v | 210.828.9719 f | TBAE Firm Reg BR1010
chesneymorales.com

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EM202


E302 1/8" = 1'-0"



JOB NO: 200027(cz) DATE: 02/05/2021 DRAWN BY:

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minimum minimu

					EXISTIN	IG I	PANEL	_ "	MS	SB" (G.	.E.)	)				
LOCATIO	DN:	MAIN ELEC. RO	MOC		VOLT	AGE:	277/480	٧		ŀ	KAIC:	25				
MOUNTI	NG:	SURFACE			PH	IASE:	3	Р	/ 4V	V CO	DES:	0=EQPT, 1=RCP	Γ, 2=LTG, 3=A/C	C, 4=HEAT		
<b>ENCLOS</b>	URE:	NEMA 1	STYLE:		BUSS	600	Α				5=CONTINUOUS	MOTORS, 6=LF	RGST MOTOR			
BRKR M	TG:	BOLT-ON				MCB:	600	Α		ACCESSOF	RIES:	GROUND BUS, 1	8 SPACE			
BREAKE	RS:	SERIES RATE	D. 75 DEGREE 1	TERMINALS		MLO:		Α				KEYED NOTES 1	AND 2.			
CODE	BRKR		CIRCUIT USE			CKT	LOAD	Α	ВС	LOAD	СКТ		CIRCUIT USE		BRKR	CC
						1		X			2					
	100/3	EXISTING PAN	IEL "L1A"			3			X		4	SURGE PROT. D	EVICE		60/3	
						5			X		6					
						7		X			8				200/3	
175/3		EXISTING XFMR "T1"				9			X		10	NEW PANEL "L18	NEW PANEL "L1B"			
						11			X		12					
						13		X			14		EVICTING DANIEL III OII			
	250/3	EXISTING PAN	EXISTING PANEL "L1"			15			X		16	EXISTING PANEL "L2"			250/3	
				. = 2		17			Х		18					
BULLOF	_	EQPT VA	RCPT VA	LTG VA	AC/HEAT VA		MOTORS			CONN VA		FTL VA	PANEL VA	PHASE AMP		
PHASE		15447	26023	5317	95993		0			142780			132915	480		
PHASE		16500	24138	5364	77103		0			123105			114062	412		
PHASE		20423	21466	3354	82977		0			128220			119824	433		
TOTAL		52370	71626	14036	256074		0			394105	D.4	NEL CURTOTAL.	366801	AMDO		
DEC		L DESIGN KVA:	366.80									NEL SUBTOTAL:	441	AMPS		
HES	SERVE (	CAPACITY KVA:	73.36									ERVE CAPACITY:	66	AMPS		
KEYED N		TOTAL KVA:	440.16							PANE	L DE	SIGN CURRENT:	507	AMPS		

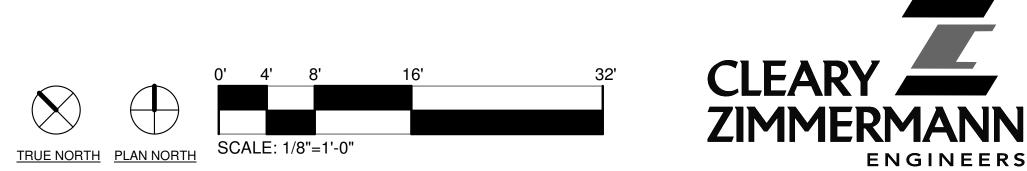2. AFTER COMPLETION OF WORK IN THIS PANEL, CONTRACTOR SHALL FIELD-TRACE BRANCH CIRCUITS AND PROVIDE A NEW TYPED DIRECTORY LISTING EQUIPMENT SERVED FOR INDIVIDUAL LOAD CONNECTIONS OR ROOM NUMBERS FOR MULTIPLE DEVICES BEING CONNECTED (SUCH AS LIGHTING FIXTURES OR RECEPTACLES).

					EXISTIN	10	PANE	_	_	" (G.E.	.)					
OCATI	ON:	MAIN ELEC. R	OOM		VOLT	AGE:	277/480	V		I	KAIC:	25				
<b>IOUNT</b>	ING:	SURFACE			PH	IASE:	3	P /	4V	v co	DES:	0=EQPT, 1=RCP	T, 2=LTG, 3=A/C	C, 4=HEAT		
NCLO:	SURE:	NEMA 1	STYLE:		BUS	SING:	400	Α				5=CONTINUOUS	MOTORS, 6=LF	RGST MOTOR		
BRKR M	/ITG:	BOLT-ON				MCB:		Α		ACCESSO	RIES:	GROUND BUS, 4	12 SPACE			
BREAK	ERS:	SERIES RATE	D. 75 DEGREE	TERMINALS		MLO:	400	Α				KEYED NOTES 1	I AND 2.			
CODE	BRKR		CIRCUIT USE			CKT	LOAD	АВ	С	LOAD	CKT		CIRCUIT USE			
0						1	10,500	X		5,320	2					3
0	60/3	ELEVATOR LC	BBY			3	10,500	X		5,320	4	AHU1- ROOM 21	7		60/3	3
0						5	10,500		Х	5,320	6					3
3						7	5,320	X			8				30/3	
3	40/3	AHU-2 ROOM	217			9	5,320	X			10	SPARE	SPARE			
3						11	5,320		X		12					
						13		X		2,500	14					3
	30/3	SPARE				15		X		2,500	16	CHP-1 - RM. 125			20/3	3
						17			Х	2,500	18					3
3						19	3,233	X		2,106	20					3
3	30/3	FCU-4				21	3,233	X		2,106	22				20/3	3
3						23	3,233		X	2,106	24					3
	30/1	SPARE				25		X		7,127		FPB1-10			35/1	3
3	35/1	FPB1-5				27	7,626	X	_	3,828		FPB1-8			20/1	3
3	30/1	FPB1-11				29	5,828		X	4,327		FPB1-7			25/1	3
3	25/1	FPB1-12				31	4,327	X		7,127	32				35/1	3
3	20/1	FPB1-3				33	2,327	X				SPARE			20/1	
3	30/1	FPB1-4				35	6,327		X		36	SPARE			20/1	
3	00/0	5011.4				37	3,500	X	,		38	00405				
3	30/3	FCU-1				39	3,500	X			40	SPARE			50/3	
3		EODT VA	DODT VA	1.70.1/4	AC/UEATA/A	41	3,500		X	000101074	42	ETI MA	DANIEL VA	DUIA OF ANAD		
DLIAGI	- ^	EQPT VA	RCPT VA	LTG VA	AC/HEAT VA		MOTORS			CONN VA		FTL VA	PANEL VA	PHASE AMP		
PHASE		10500	0	0	40560	-	0		+	51060			51060	184		
PHASE		10500	0	0	35760	-	0		+	46260	1		46260	167		
PHASE		10500	0	0	38461		0			48961	-		48961	177		
TOTAL		31500 L DESIGN KVA:	0	0	114781		0			146281	D^	NEL CURTOTAL:	146281	AMDO		
חר			146.28									NEL SUBTOTAL:	176	AMPS		
KE	SERVE	CAPACITY KVA:	29.26									ERVE CAPACITY:	26	AMPS		
	NOTES:	TOTAL KVA:	175.54							PANE	L DE	SIGN CURRENT:	202	AMPS		

SERVED FOR INDIVIDUAL LOAD CONNECTIONS OR ROOM NUMBERS FOR MULTIPLE DEVICES BEING CONNECTED (SUCH AS LIGHTING FIXTURES OR RECEPTACLES).

	INVERTER "INV1"	
LOCATION:	ELECTRICAL 110	
MANUFACTURER:	MEYERS	
MODEL:	LV-4-R-1-B-20-06-RT	
VOLTAGE:	277V (IN), 277V (OUT)	
FEATURES:	SUMMARY ALARM CONTACT, REMOTE TEST SWITCH.	
FED FROM:	L1B-3	
BREAKER	LOAD	LOAD
NO.	TYPE	(VA)
1 (20A/1P)	1ST FLOOR LOBBY LTS	484
2 (20A/1P)	SPARE	
3 (20A/1P)	SPARE	
4 (20A/1P)	SPARE	
5 (20A/1P)	SPARE	
6 (20A/1P)	SPARE	
TOTAL CONNECTED	O (VA)	484
INVERTER RATING	(VA)	750
0% INVERTER DER	ATING (VA)	0
SPARE CAPACITY (	VA)	266

MARK	CONDUIT	CONDUCTORS
1020	1 - 1/2" Conduit	2 - #12 and 1 - #12 Ground
1030	1 - 3/4" Conduit	2 - #10 and 1 - #10 Ground
1050	1 - 3/4" Conduit	2 - #8 and 1 - #8 Ground
1065	1 - 3/4" Conduit	2 - #6 and 1 - #8 Ground
	1 - 3/4 Conduit	2 - #4 and 1 - #8 Ground
1085		
1100	1 - 1" Conduit	2 - #3 and 1 - #6 Ground
1115	1 - 1-1/4" Conduit	2 - #2 and 1 - #6 Ground
2020	1 - 1/2" Conduit	3 - #12 and 1 - #12 Ground
2030	1 - 3/4" Conduit	3 - #10 and 1 - #10 Ground
2050	1 - 3/4" Conduit	3 - #8 and 1 - #8 Ground
2065	1 - 3/4" Conduit	3 - #6 and 1 - #8 Ground
2085	1 - 1" Conduit	3 - #4 and 1 - #8 Ground
2100	1 - 1-1/4" Conduit	3 - #3 and 1 - #6 Ground
2115	1 - 1-1/4" Conduit	3 - #2 and 1 - #6 Ground
3020	1 - 3/4" Conduit	4 - #12 and 1 - #12 Ground
3030	1 - 3/4" Conduit	4 - #10 and 1 - #10 Ground
3050	1 - 3/4" Conduit	4 - #8 and 1 - #8 Ground
3065	1 - 1" Conduit	4 - #6 and 1 - #8 Ground
3085	1 - 1-1/4" Conduit	4 - #4 and 1 - #8 Ground
3100	1 - 1-1/4" Conduit	4 - #3 and 1 - #6 Ground
3115	1 - 1-1/4" Conduit	4 - #2 and 1 - #6 Ground
	'	
SY0020	1 - 3/4" Conduit	4 - #12 and 1 - #8 Ground
SY0030	1 - 3/4" Conduit	4 - #10 and 1 - #8 Ground
SY0050	1 - 3/4" Conduit	4 - #8 and 1 - #8 Ground
SY0065	1 - 1" Conduit	4 - #6 and 1 - #8 Ground
SY0085	1 - 1-1/4" Conduit	4 - #4 and 1 - #8 Ground
SY0100	1 - 1-1/4" Conduit	4 - #3 and 1 - #6 Ground
SY0115	1 - 1-1/4" Conduit	4 - #2 and 1 - #6 Ground
SY0130	1 - 1-1/2" Conduit	4 - #1 and 1 - #6 Ground
SY0150	1 - 2" Conduit	4 - #1/0 and 1 - #6 Ground
SY0175	1 - 2" Conduit	4 - #2/0 and 1 - #4 Ground
SY0200	1 - 2" Conduit	4 - #3/0 and 1 - #4 Ground
SY0230	1 - 2-1/2" Conduit	4 - #4/0 and 1 - #2 Ground
SY0255	1 - 3" Conduit	4 - #250 kcmil and 1 - #2 Ground
SY0310	1 - 3" Conduit	4 - #350 kcmil and 1 - #2 Ground
SY0335	1 - 3-1/2" Conduit	4 - #400 kcmil and 1 - #2 Ground
	1 - 3-1/2" Conduit	
SY0380		4 - #500 kcmil and 1 - #2 Ground
SY0400	2 - 2" Conduit	EACH with 4 - 3/0 and 1 - #2 Ground
SY0420	1 - 4" Conduit	4 - #600 kcmil and 1 - #2 Ground
SY0460	2 - 2-1/2" Conduits	EACH with 4 - #4/0 and 1 - #2 Ground
SY0510	2 - 2-1/2" Conduits	EACH with 4 - #250 kcmil and 1 - #1 Ground
SY0570	2 - 2-1/2" Conduits	EACH with 4 - #300 kcmil and 1 - #1 Ground
SY0620	2 - 3" Conduits	EACH with 4 - #350 kcmil and 1 - #1/0 Ground
SD0020	1 - 3/4" Conduit	3 - #12 and 1 - #8 Ground
SD0020	1 - 3/4" Conduit	3 - #10 and 1 - #8 Ground
SD0050	1 - 3/4" Conduit	3 - #8 and 1 - #8 Ground
SD0065	1 - 3/4" Conduit	3 - #6 and 1 - #8 Ground
SD0085	1 - 1" Conduit	3 - #4 and 1 - #8 Ground
SD0100	1 - 1-1/4" Conduit	3 - #3 and 1 - #6 Ground
SD0115	1 - 1-1/4" Conduit	3 - #2 and 1 - #6 Ground
SD0130	1 - 1-1/2" Conduit	3 - #1 and 1 - #6 Ground
SD0150	1 - 1-1/2" Conduit	3 - #1/0 and 1 - #6 Ground
SD0175	1 - 2" Conduit	3 - #2/0 and 1 - #4 Ground
SD0200	1 - 2" Conduit	3 - #3/0 and 1 - #4 Ground
SD0230	1 - 2" Conduit	3 - #4/0 and 1 - #2 Ground
SD0250	1 - 2-1/2" Conduit	3 - #250 kcmil and 1 - #2 Ground
SD0310	1 - 3" Conduit	3 - #350 kcmil and 1 - #2 Ground
SD0380	1 - 3" Conduit	3 - #500 kcmil and 1 - #1/0 Ground
SD0420	1 - 3" Conduit	3 - #600 kcmil and 1 - #1/0 Ground
SD0460	2 - 2" Conduits	EACH with 3 - 4/0 and 1 - #2 Ground
SD0510	2 - 2-1/2" Conduits	EACH with 3 - #250 kcmil and 1 - #1 Ground
SD0570	2 - 2-1/2" Conduits	EACH with 3 - #300 kcmil and 1 - #1 Ground
SD0620	2 - 3" Conduits	EACH with 3 - #350 kcmil and 1 - #1/0 Ground

_		
	20 AMP CIRCUIT VOLTAGE	DROP
	120V 20 Amp	MAX ONE WAY

1. Wet location (underground or outdoors) use THWN. Otherwise THHN.

Utility - riser poles (follow Utility guidelines or minimum schedule 80).

4. Motor Connections shall be flexible non-metallic conduit for water equipment

EMT to IMC prior to penetrating walls to the exterior).

5. All conduit penetrations in rated walls shall be firestopped.

6. See drawings for any special requirements.

2. Conduit Types; underground - schedule 40 PVC; indoors - EMT; outdoor exposed - IMC.

3. Provide transitions to conduit changes prior to different environment (ex. Transition from

120V 20 Amp		MAX ONE WAY
CONDUCTOR	CONDUIT	LENGTH OF CIRCUIT
2 - #12 and 1 - #12 GRD	3/4" C	100 Feet
2 - #10 and 1 - #10 GRD	3/4" C	160 Feet
2 - #8 and 1 - #8 GRD	3/4" C	260 Feet
2 - #6 and 1 - #6 GRD	1" C	400 Feet
2 - #4 and 1 - #4 GRD	1" C	650 Feet
REFER TO NOTES ON DRAWINGS GR	EATER THAN 650 FEET	
277V 20 Amp		MAX ONE WAY
CONDUCTOR	CONDUIT	LENGTH OF CIRCUIT
2 - #12 and 1 - #12 GRD	3/4" C	220 Feet
2 - #10 and 1 - #10 GRD	3/4" C	360 Feet
2 - #8 and 1 - #8 GRD	1" C	600 Feet
REFER TO NOTES ON DRAWINGS GR	FATER THAN 600 FEET	

1) CONTRACTOR SHALL FOLLOW CIRCUIT VOLTAGE DROP CHART DISTANCE FOR SIZING CIRCUITING. CONTRACTOR SHALL UPSIZE CONDUIT AND WIRE BASED UPON ACTUAL FEEDER DISTANCE INSTALLED. 2) SEE FEEDER SCHEDULE FOR ADDITIONAL FEEDER SIZES. 3) PULL IN NYLON PULL CORD WITH CONDUCTORS UP TO 300 FEET, PULL IN MULE TAPE WITH CONDUCTORS OVER 300 FEET. 4) CHART CONDUIT SIZES ARE BASED UPON SINGLE CIRCUITS. CONTRACTOR SHALL UPSIZE CONDUIT AS PER NEC FOR MULTIPLE CIRCUITS. WIRE GAUGE SHALL REMAIN AS PER CHART.



**ELECTRICAL SCHEDULES** 

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**Revision Schedule** 

Description Date Addendum 05/03/21



JOB NO: 200027(cz) 02/05/2021

DRAWN BY: CHECKED BY: TD

SHEET IN ANY FORM WITHOUT PRIOR WRITTEN AUTHORIZATION OF CHESNEY MORALES PARTNERS, INC.

LOCATI	ON:	2ND FLR. ELEC		EXISTIN		208/120			-	KAIC:	10					
MOUNT		SURFACE	AGE: ASE:	208/120	V	' P/4			0=EQPT, 1=RCPT		A LIEAT					
ENCLOS		NEMA 1	ASE. SING:		A		.vv CC	יטבט.	5=CONTINUOUS		•					
BRKR M		BOLT-ON	STYLE:			MCB:	150	A		ACCESSO	DIEC.	GROUND BUS, 42		NG31 WOTON		
BREAKE		SERIES RATE	MLO:		A		ACCESSO	NIES.	KEYED NOTES 1							
DNLAN	LNO.	SERIES RATE	5. 75 DEGREE	ILNIIINALO		VILO.			`			KETED NOTES T	AND 2.			
CODE	BRKR		CIRCUIT USE			СКТ	LOAD		ВС	LOAD	СКТ		CIRCUIT USE		BRKR	
						1		X		659	2	EXISTING RECEP			20/1	
	100/3	PANEL "P2A"				3			X	659	4	EXISTING RECEP			20/1	
		(REF. KEYED)				5			X		6	EXISTING RECEP			20/1	
1	20/1	EXISTING REC				7	659	X		659	8	EXISTING RECEF			20/1	
1	20/1	EXISTING REC				9	659		X	659	10	EXISTING RECEF			20/1	
1	20/1	EXISTING REC				11	659		X		12	EXISTING RECEF	20/1	$\perp$		
1	20/1	EXISTING REC				13	659	X		659	14	EXISTING RECEF			20/1	
1	20/1	EXISTING REC				15	659		X	659	16	EXISTING RECEP			20/1	
1	20/1	EXISTING REC				17	659		X		18	EXISTING RECEP			20/1	
1	20/1	EXISTING REC				19	659	Х		659	20	EXISTING RECEF			20/1	_
1 20/1 EXISTING RECEPT.				21	659	$\perp$	X	659		EXISTING RECEPT.			20/1			
1	20/1	EXISTING REC				23	659		X	659		EXISTING RECEP	20/1			
1	20/1	EXISTING REC				25	659	X				EXIST. LOAD		20/1		
1	20/1	EXISTING REC				27	659	<u></u> '	X			EXIST. LOAD			20/1	
1	20/1	EXISTING REC	29	659		X			EXIST. LOAD	_		20/1				
1	20/1	EXISTING REC			31	659	X		659		EXISTING RECER		20/1			
	20/1	EXISTING LOA	33			X	659			기.		20/1				
1	20/1	EXISTING REC	35	659		X			EXIST. LOAD			20/1				
1	20/1	EXISTING REC				37	659	Х		659		EXISTING RECEP			20/1	
1	20/1	EXISTING REC		39	659	+	X	659		EXISTING RECEP	20/1					
1	20/1	EXISTING REC	RCPT VA	LTG VA	AC/HEAT VA	41	659 MOTORS		X	CONN VA	42	EXISTING RECEF	PANEL VA	PHASE AMP	20/1	
PHASE	= Δ	40	8564	0	425		0	+		9029		FILVA	6461	54	+	
PHASE		60	7905	0	425		0	+		8390	+		6020	50	+	
PHASE		0	8505	0	0		0			8505			5955	50		+
TOTAL		100	24973	0	850		0			25923			18437			+
PANEL DESIGN KVA: 18.44		1					PA	NEL SUBTOTAL:	51	AMPS						
RE		CAPACITY KVA:	3.69									RVE CAPACITY:	8	AMPS		
		TOTAL KVA:	22.12									SIGN CURRENT:	59	AMPS		

1. CONTRACTOR SHALL PROVIDE A NAMEPLATE READING ON PANEL EXTERIOR: "FED FROM XXXX", XXXX INDICATES THE SOURCE OF POWER.

2. AFTER COMPLETION OF WORK IN THIS PANEL, CONTRACTOR SHALL FIELD-TRACE BRANCH CIRCUITS AND PROVIDE A NEW TYPED DIRECTORY LISTING EQUIPMENT SERVED FOR INDIVIDUAL LOAD CONNECTIONS OR ROOM NUMBERS FOR MULTIPLE DEVICES BEING CONNECTED (SUCH AS LIGHTING FIXTURES OR RECEPTACLES).

SERVED FOR INDIVIDUAL LOAD CONNECTIONS OR ROOM NUMBERS FOR MULTIPLE DEVICES BEING CONNECTED (SUCH AS LIGHTING FIXTURES OR RECEPTACLES).

					EXISTING	PANE	L	"F	P1A" (	(G.I	Ξ.)					
LOCATI	ON:	TRAINING RO	OM 114		VOLTAGE:		V			•	AIC:					
MOUNT		SURFACE		PHASE:	3	Р	/	4W	COD	ES:	0=EQPT, 1=RCP	Γ, 2=LTG, 3=A/C	C, 4=HEAT			
ENCLOSURE:		NEMA 1	STYLE:		BUSSING:	150	Α					5=CONTINUOUS				
BRKR M	ITG:	BOLT-ON			MCB:	150	Α		ACCE	SSOR	IES:	GROUND BUS, 3				
BREAKERS:		SERIES RATE	D. 75 DEGREE	TERMINALS	MLO:						KEYED NOTES 1					
CODE	BRKR		CIRCUIT USE	CKT	LOAD	Α	В	C LOA	\D	CKT		CIRCUIT USE		BRKR	CODE	
1	20/1	RECEPT. NOR	TH WALL		1	566	X		560	6	2	RECEPT. NORTH	l WALL		20/1	1
1	20/1	RECEPT. EAST	ΓWALL		3	566		Х	566	6	4	RECEPT. EAST V	VALL		20/1	1
1	20/1	RECEPT. SOU	TH WALL		5	566			X 566	6	6	RECEPT. SOUTH	I WALL		20/1	1
	20/1				7		Х		566	6	8	RECEPT. SURF F	RACEWAY		20/1	1
1	20/1	RECEPT. MICF	ROWAVE		9	566		X	566	6	10	RECEPT. SURF F	RACEWAY		20/1	1
1	20/1	RECEPT. COL	UMN		11	566			X 560	6	12	RECEPT. SURF F	RACEWAY		20/1	1
1	20/1	RECEPT. WES	T WALL		13	566	X				14	SPARE			20/1	
	20/1	SPARE			15			X			16	SPARE			20/1	
	20/1	SPARE			17				X		18	SPARE			20/1	
	20/1	SPARE			19		Х				20	SPARE			20/1	
	20/1	SPARE			21			X			22	SPARE			20/1	
	20/1	SPARE			23				X		24	SPARE			20/1	
	20/1	SPARE			25		X				26	SPARE			20/1	
	20/1	SPARE			27			X			28	SPARE			20/1	
	20/1	SPARE			29				X		30	SPARE			20/1	
	20/1	SPARE			31		X					SPARE			20/1	
	20/1	SPARE			33			Х				SPARE			20/1	
	20/1	SPARE			35				X		36	SPARE			20/1	
		EQPT VA	RCPT VA	LTG VA	AC/HEAT VA	MOTORS			CONN			FTL VA	PANEL VA	PHASE AMP		
PHASE		0	2264	0	0	0			226				2264	19		
PHASE		0	2264	0	0	0			226				2264	19		
PHASE		0	2264	0	0	0			226				2264	19		
TOTAL		0	6791	0	0	0			679	91			6791			
		L DESIGN KVA:	6.79									NEL SUBTOTAL:	19	AMPS		
RE	SERVE C	CAPACITY KVA:	1.36									RVE CAPACITY:	3	AMPS		
		TOTAL KVA:	8.15						F	PANEL	DES	SIGN CURRENT:	22	AMPS		
KEYED	NOTES:															
1. CON	TRACTO	R SHALL PROVI	DE A NAMEPLA	ATE READING	ON PANEL EXTERIOR	: "FED FRON	ЛXX	XΧ	(", XXXX II	NDICA	TES	THE SOURCE OF	POWER.			
2. AFTE	R COMP	LETION OF WO	RK IN THIS PAI	NEL, CONTRA	CTOR SHALL FIELD-TF	RACE BRANG	CH C	CIR	<b>RCUITS AN</b>	ID PRO	OVID	E A NEW TYPED [	DIRECTORY LIS	STING EQUIPMENT		

CODE
1
1
		NEW PANEL "P2A"															
OCAT	ION:	2ND FLR. ELEC. RM. VOLTAGE: 208/120 V KAIC: 10															
MOUNTING: SURFACE		PH	IASE:	3	Ρ	/	4W	С	ODES:	0=EQPT, 1=RCP	T, 2=LTG, 3=A/C	, 4=HEAT					
ENCLOSURE:		NEMA 1	SING:	150	Α					5=CONTINUOUS	MOTORS, 6=LF	RGST MOTOR					
BRKR MTG:		BOLT-ON				MCB:	150	Α		AC	CCESSO	ORIES:	GROUND BUS, 4	12 SPACE			
BREAKERS:		SERIES RATE	MLO:		Α					KEYED NOTES 1	1 AND 2.						
CODE	BRKR		CIRCUIT USE			CKT	LOAD	Α	В	С	LOAD	CKT		CIRCUIT USE		BRKR	COD
1	20/1	EXISTING REC	CEPT (RELOCA	TED FROM "P2'	').	1	659	Х			360	2	BREAK RM/CON	IF RM TVS		20/1	1
1	20/1	EXISTING REC	CEPT (RELOCA	TED FROM "P2'	').	3	659		X		800	4	BREAKROOM RI	EFR		20/1 GFI	1
1	20/1	EXISTING REC	CEPT (RELOCA	TED FROM "P2'	').	5	659			Х	1,000		UNISEX TOWEL		1	20/1	1
0	20/1	MENS FLUSH	VALVES			7	40	Х		~	180	\^\®\	LIMISEX PCRX	~~~		20/1	1
0	20/1	WOMENS FLU	ISH VALVES			9	60		X		360	10	CONFERENCE F	LOOR RCPT		20/1	1
1	20/1 GFI	WATER FOUN	TAIN			11	600			×	360	12	CONFERENCE F	LOOR RCPT		20/1	1
3	20/1	EF-1				13	425	Х			720	14	OFFICE RCPTS			20/1	1
3	20/1	EF-2				15	425		Х	7		16	SPARE			20/1	
	20/1	SPARE				17				$\sqrt{x}$		رهل ک	SPARE			20/1	
	20/1	SPARE				19		Х				20	SPARE			20/1	
	20/1	SPARE				21			Х			22	SPARE			20/1	
	20/1	SPARE				23				Х		24	SPARE			20/1	
	20/1	SPARE						Х				26	SPARE			20/1	
		BUSSED SPAC	27			Х			28	BUSSED SPACE							
		BUSSED SPAC	29				X		30	BUSSED SPACE							
		BUSSED SPAC	CE		31		Х				32	BUSSED SPACE					
		BUSSED SPAC	CE			33			Х			34	BUSSED SPACE				
		BUSSED SPAC	CE			35				Х		36	BUSSED SPACE				
		BUSSED SPAC		37		Х				38	BUSSED SPACE						
		BUSSED SPAC	39			Х			40	BUSSED SPACE							
		BUSSED SPAC	CE			41				X		42	BUSSED SPACE				
		EQPT VA	RCPT VA	LTG VA	AC/HEAT VA		MOTORS			CC	AV NNC		FTL VA	PANEL VA	PHASE AMP		
PHAS	EΑ	40	1919	0	425		0				2384			2384	20		
PHAS	EΒ	60	1819	0	425		0				2304			2304	19		
PHAS	EC	0	2619	0	0		0				2619			2619	22		
TOTAL		100	6356	0	850		0				7306			7306			
	PANEI	DESIGN KVA:	7.31									PA	NEL SUBTOTAL:	20	AMPS		
RESERVE CAPACITY KVA: 1.46				RESERVE CAPACITY: 3 AMPS								AMPS					
		TOTAL KVA:	8.77								PAN	NEL DES	SIGN CURRENT:	23	AMPS		
(EYED	NOTES:																
		R SHALL PROVII	DE A NAMEPLA	TE READING O	N PANEL EXTE	RIOR:	"FED FROM	I XX	XX"	', XXX	X INDIC	ATES 1	THE SOURCE OF	POWER.			
		LETION OF WOR								,					TINO EOLUDMENT		

EXISTING PANEL "TEP1" (G.E.)

PHASE: 3 P / 4W CODES: 0=EQPT, 1=RCPT, 2=LTG, 3=A/C, 4=HEAT

X 360 6 EXISTING LOAD

360 8 EXISTING LOAD

566 10 EXISTING LOAD

566 12 EXISTING LOAD

566 14 EXISTING LOAD

18 SPACE

20 SPACE

22 SPACE 24 SPACE

16 EXISTING LOAD

FTL VA

PANEL SUBTOTAL:

RESERVE CAPACITY:

PANEL DESIGN CURRENT:

KAIC: 10 PHASE: 3 P / 4W CODES: 0=EQPT, 1=RCPT, 2=LTG, 3=A/C, 4=HEAT

X 566 4 EXISTING RECEPT

X 566 6 EXISTING RECEPT.

566 8 EXISTING RECEPT.

566 12 EXISTING RECEPT.

566 14 EXISTING RECEPT.

566 16 EXISTING RECEPT

566 20 EXISTING RECEPT.

22 SPARE

24 SPARE

26 SPARE

28 SPARE

30 SPARE

32 SPARE

34 SPARE

36 SPARE

FTL VA

RESERVE CAPACITY:

PANEL DESIGN CURRENT:

X 566 18 EXISTING RECEPT.

10 EXISTING RECEPT.

MCB: 150 A ACCESSORIES: GROUND BUS, 36 SPACE

 CKT
 LOAD
 A
 B
 C
 LOAD
 CKT
 CIR

 1
 566
 X
 566
 2
 EXISTING RECEPT.

CONN VA

5093

12451

MCB: A ACCESSORIES: GROUND BUS, 24 SPACE

 CKT
 LOAD
 A
 B
 C
 LOAD
 CKT
 C

 1
 360
 X
 360
 2
 EXISTING LOAD

3 360 X 360 4 EXISTING LOAD

CONN VA

2572

1852

5=CONTINUOUS MOTORS, 6=LRGST MOTOR

PANEL VA PHASE AMP

AMPS

2572

3344

1852 7768

5=CONTINUOUS MOTORS, 6=LRGST MOTOR

PANEL VA PHASE AMP

AMPS

AMPS

4592

3572

3061

11225

36

KEYED NOTES 1 AND 2.

20/1 1

KEYED NOTES 1 AND 2.

VOLTAGE: 208/120 V

BUSSING: 125 A

MLO: 125 A

LOCATION: MAIN ELEC. ROOM

BREAKERS: SERIES RATED. 75 DEGREE TERMINALS

CIRCUIT USE

2572

3344

EQPT VA RCPT VA LTG VA AC/HEAT VA MOTORS

1. CONTRACTOR SHALL PROVIDE A NAMEPLATE READING ON PANEL EXTERIOR: "FED FROM XXXX", XXXX INDICATES THE SOURCE OF POWER.

2. AFTER COMPLETION OF WORK IN THIS PANEL, CONTRACTOR SHALL FIELD-TRACE BRANCH CIRCUITS AND PROVIDE A NEW TYPED DIRECTORY LISTING EQUIPMENT SERVED FOR INDIVIDUAL LOAD CONNECTIONS OR ROOM NUMBERS FOR MULTIPLE DEVICES BEING CONNECTED (SUCH AS LIGHTING FIXTURES OR RECEPTACLES).

EXISTING PANEL "P1B" (G.E.)

VOLTAGE: 208/120 V

BUSSING: 150 A

MLO: A

566

19 566 X

566

25 566 X

MOTORS

2. AFTER COMPLETION OF WORK IN THIS PANEL, CONTRACTOR SHALL FIELD-TRACE BRANCH CIRCUITS AND PROVIDE A NEW TYPED DIRECTORY LISTING EQUIPMENT SERVED FOR INDIVIDUAL LOAD CONNECTIONS OR ROOM NUMBERS FOR MULTIPLE DEVICES BEING CONNECTED (SUCH AS LIGHTING FIXTURES OR RECEPTACLES).

1. CONTRACTOR SHALL PROVIDE A NAMEPLATE READING ON PANEL EXTERIOR: "FED FROM XXXX", XXXX INDICATES THE SOURCE OF POWER.

23 566

MOUNTING: SURFACE ENCLOSURE: NEMA 1

BRKR MTG: BOLT-ON

1 20/1 EXISTING LOAD 1 20/1 EXISTING LOAD

1 20/1 EXISTING LOAD 1 20/1 EXISTING LOAD

1 20/1 EXISTING LOAD

1 20/1 EXISTING LOAD

1 20/1 EXISTING LOAD

1 20/1 EXISTING LOAD

1 20/1 EXISTING LOAD

LOCATION: MUD ROOM 113

1 20/1 EXISTING RECEPT.

1 20/1 EXISTING RECEPT 1 20/1 EXISTING RECEPT.

1 20/1 EXISTING RECEPT.

20/1 SPARE

1 20/1 EXISTING RECEPT.

1 20/1 EXISTING RECEPT.

1 20/1 EXISTING RECEPT.

1 20/1 EXISTING RECEPT. 1 20/1 EXISTING RECEPT.

1 20/1 EXISTING RECEPT.

1 20/1 EXISTING RECEPT.

1 20/1 EXISTING RECEPT.

20/1 SPARE

20/1 SPARE

20/1 SPARE

20/1 SPARE

20/1 SPARE

PANEL DESIGN KVA: 11.23 RESERVE CAPACITY KVA: 2.25

TOTAL KVA: 13.47

PHASE A PHASE B

PHASE C

KEYED NOTES:

TOTAL

ENCLOSURE: NEMA 1

BRKR MTG: BOLT-ON

SURFACE

BREAKERS: SERIES RATED. 75 DEGREE TERMINALS

EQPT VA RCPT VA LTG VA AC/HEAT VA

5093

3962

PHASE A

PHASE B

KEYED NOTES:

MOUNTING:

SPACE

SPACE

PANEL DESIGN KVA: 7.77

TOTAL KVA: 9.32

RESERVE CAPACITY KVA: 1.55



**ELECTRICAL SCHEDULES** 


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CHECKED BY:

**Revision Schedule** 

Description Date Addendum #1 05/03/21

JOB NO: 200027(cz) 02/05/2021 DRAWN BY:



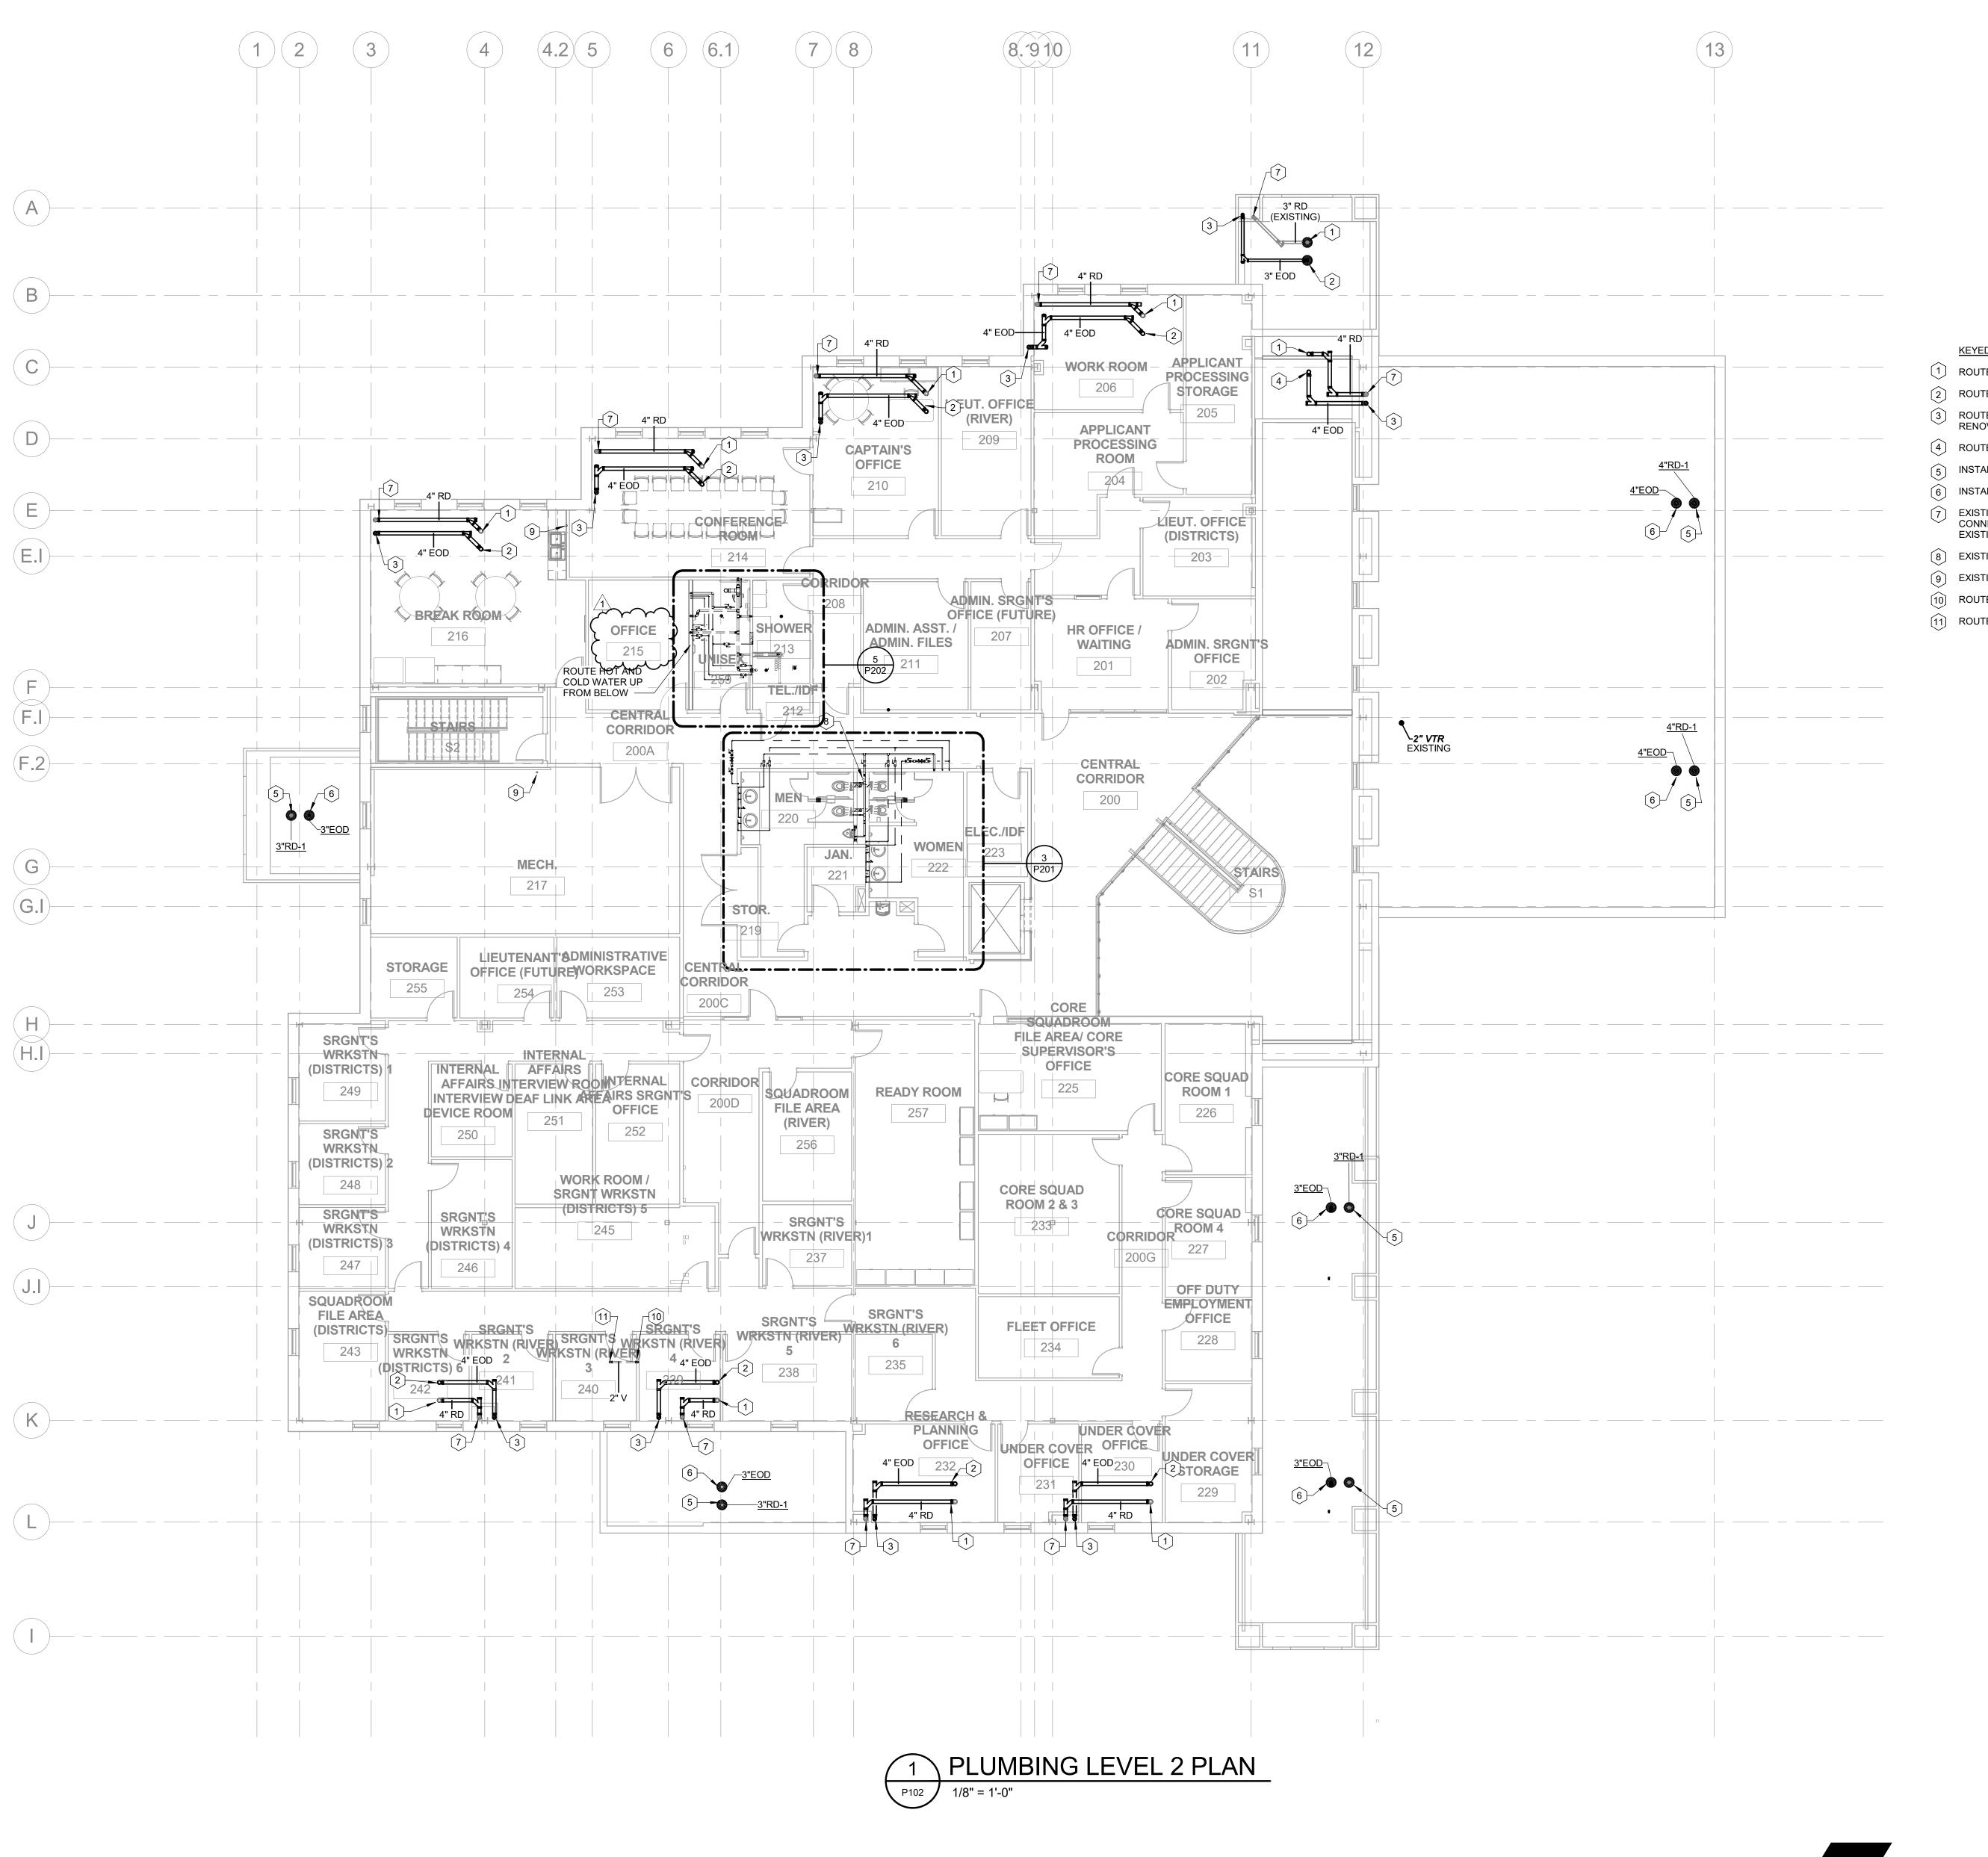


Description

Addendum #1 05/03/21

KEYED PLUMBING NOTES:

- 1 ROUTE 4" RD FROM RD-1 ABOVE AS INDICATED.
- ROUTE 4" EOD FROM EOD-1 ABOVE AS INDICATED.
- ROUTE 4" EOD DOWN TO BELOW WITH MINIMUM RENOVATION AS POSSIBLE.
- (4) ROUTE 4" EOD FROM EOD-1 ABOVE.
- INSTALL NEW RD-1 AS INDICATED.
- INSTALL NEW EOD-1 AS INDICATED.
- EXISTING VERTICAL ROOF DRAIN PIPING TO REMAIN. CONNECT NEW HORIZONTAL ROOF DRAIN PIPING TO EXISTING VERTICAL BRANCH.
- EXISTING 4" VENT RISER UP TO 4" VTR.
- EXISTING 2" VENT RISER UP TO 2" VTR.
- ROUTE 2" VENT RISER UP FROM BELOW.
- ROUTE 2" VENT RISER UP TO NEW 2" VTR.

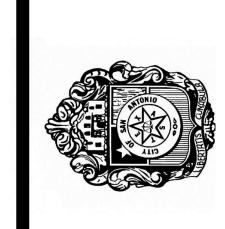

JOB NO: 200027(cz) 02/05/2021 DATE: DRAWN BY: CHECKED BY: TEW

